

EXHIBIT H

3-YEAR ASBESTOS RE-INSPECTION REPORT

.....

WEST SCRANTON HIGH SCHOOL SCRANTON, PA

prepared for:

**SCRANTON SCHOOL DISTRICT
425 North Washington Avenue
Scranton, Pa. 18505**

CONSULTANTS:

Guzek Associates, Inc.
401 Davis Street
Clarks Summit, PA 18411

PROJECT: #SSD.19_751

Updated:

October 2019

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ASBESTOS INSPECTION

For the property known as:

WEST SCRANTON HIGH SCHOOL

SECTION 1 EXECUTIVE SUMMARY

An Asbestos Materials Inspection Survey was conducted on October 2, 2019 at the above-listed location. The purpose of the survey was to visually locate, identify, and quantify asbestos-containing building materials. The survey was conducted by Certified Asbestos Inspectors, Chris Notari (DLI Asbestos Inspector Certification #027028), Brent Tripp (DLI Asbestos Inspector Certification #053975) and Gary Marshall.

All accessible rooms and areas of the building were entered for inspection of suspected asbestos materials. Suspected asbestos materials not previously sampled (if applicable) were sampled and sent to a laboratory for analyses to confirm or negate the suspicion of asbestos content. Other suspect materials were assumed to contain asbestos.

The results are summarized as follows:

A. Asbestos-containing Materials

1. All confirmed or assumed (roofing materials, chalkboard mastic, etc.) asbestos-containing materials are listed in Appendix A. Materials that were tested and found not to contain asbestos are also listed in Section 6.
2. Recommendations

Recommendations are given in relation to renovation activities for the school building in Section 7.

SECTION 2 INTRODUCTION

An Asbestos Materials Inspection of the West Scranton High School was performed at the request Scranton School District, Scranton, PA. The purpose of the inspection was to determine the types, quantities, and conditions of confirmed or assumed asbestos-containing materials, if not previously tested.

Once suspected asbestos materials were identified, they were sampled to verify or negate the suspicion of asbestos content (roofs were not tested and were assumed to contain asbestos). All materials sampled were analyzed via EPA Method 600/R-93/116 utilizing Polarized Light Microscopy by *EMSL Analytical, Inc., a NVLAP- accredited laboratory.*

The friability of these materials was also determined. Friable materials, such as cementitious pipe insulation, are those that can be crumbled, pulverized, or reduced to powder by hand or finger pressure. Non-friable materials, such as floor tiles in good condition, are those that cannot be crumbled, pulverized, or reduced to powder by hand or finger pressure. It is possible for normally non-friable materials to be considered as friable if they are in poor or damaged condition or will be rendered friable by construction or other activities, such as drilling, sanding, crushing by heavy equipment, etc.

The Initial Asbestos Hazard Emergency Response Act (AHERA) Building Inspection Report and Management Plan which was prepared and filed in accordance with the United States Environmental Protection Agency's (EPA) Regulation 40 CFR Part 763, Subpart E – Asbestos-Containing Materials in Schools is on file and available for review at the Scranton School District Administration Offices and the West Scranton High School Administration Office.

SECTION 3 BUILDING DISCRIPTION

West Scranton High School, located at 1201 Luzerne Street, Scranton, PA is a steel and masonry building constructed in 1937. The building consists of a basement, three (3) floors, and an attic, and contains approximately 307,880 square feet of floor area.

SECTION 4 METHODS

Prior to re-inspection the following documents were reviewed by Guzek Associates, Inc.

1. Original inspection report
2. Available 3-Year Re-inspection Report
3. AHERA 6-month Periodic Surveillance Inspection Reports

Upon completion of reviewing the above referenced documentation, Guzek Associates, Inc. conducted a room-by-room and area-by-area inspection of the building to verify the locations of Asbestos Containing Materials listed in the above documents and to determined the conditions (Good, Damaged, or Significantly Damaged) of these materials. In addition, suspect materials not listed in the above documents were identified and either assumed to contain asbestos or collected and analyzed to determined asbestos content.

The asbestos inspection survey was conducted by inspectors qualified by experience, education, and training in the recognition of suspected asbestos-containing materials. Sampling was limited to only areas that were easily accessible (above ceiling tiles, operable hatches, and open areas.) No walls, chases or ceilings, etc. were penetrated during this inspection.

For those materials analyzed for asbestos content during this inspection, representative samples of "suspected" asbestos-containing materials were collected utilizing approved federal and state methods.

All Samples collected were analyzed by EMSL Analytical, Inc., Cinnaminson, NJ. Using EPA 600/R-93/116 Method using Polarized Light Microscopy

SECTION 5 REINSPECTION FINDINGS

The attached inspection forms in Appendix A indicate both the locations and assessed conditions of confirmed or assumed asbestos containing materials as identified in the building by the 2019 Re-inspection conducted by Guzek Associates, Inc.

The Scranton School District intends to continue implementation of the Operations & Maintenance Program recommendations as contained in the original AHERA Management Plan and to maintain its stringent occupational and environmental protection standards for the on-going control of the identified ACBM's within the building.

SECTION 6 INSPECTION RESULTS

A. Asbestos-containing Materials

Appendix A contains a list and drawings of all confirmed and assumed asbestos-containing materials identified in the 3-year re-inspection report for West Scranton High School conducted by Guzek Associates, Inc.. This table also includes locations and condition assessments (Good, Damaged, or Significantly Damaged).

Finally all Chain of Custody and Analytical Laboratory Reports for the 2016 3-Year Re-inspection Report are including in Appendix B.

Note: In addition to those materials listed in the Homogeneous Sampling Chart in Appendix A, the following suspected asbestos-containing materials may be present:

1. Glue pucks behind chalkboards (Category 1 non-friable material) – no access at time of inspection.
2. Fire Doors
3. Roofing Materials (including Flashing and Tar)
4. Electrical wiring insulation maybe present

Materials That Were Tested and Found Not to Contain Asbestos

- All layers of hard wall and ceiling plasters
(Does NOT include acoustical plaster found in the Band Room, Chorus Rooms, Rooms 100, 101, 103, and 105, and the Cafeteria)
- All ceiling tile (Previously tested by others)
- Ceiling Blocks in Basement
(Does NOT include Basement Storage/Maintenance Shop, See Drawing)
- Floor Leveler
- Joint Compound
- Sheetrock
- Tar Floor (Wood Shop Area)
- Mastic on Fiberglass Ends
- Burlap Wallpaper
- Textured Ceilings (1st Floor Hallway)
- Linoleum in Library, Home Economics, and Room 206

SECTION 7 RECOMMENDATIONS

- A. Any Materials listed as assumed Asbestos Containing Materials (PACM) in Appendix A shall either be assumed to contain asbestos or should be analyzed to determine asbestos content at time of disturbance
- B. All Asbestos Containing Materials in the building that are to remain in place shall be treated according to Operation and Maintenance (O&M) procedures for each specific material and as listed in the O&M plan for the West Scranton High School.
- C. All presumed or confirmed asbestos containing materials that will be potentially damaged by any activity (renovation, demolition, maintenance, etc.) shall be:
 - 1. Removed by a Pennsylvania Department of Labor and Industry (PaDLI) Certified asbestos abatement contractor prior to renovation. Final clearance air monitoring should be performed by an independent third party contracted to the school district.

Or

- 2. The Activity that will potentially disturb Asbestos Containing Materials shall be designed to avoid said disturbance.

SECTION 8 ASBESTOS INSPECTOR ACCREDITATION

Certified PA Asbestos Inspectors, Chris Notari (DLI Asbestos Inspector Certification #027028) and Brent Tripp (DLI Asbestos Inspector Certification #053975). Copies of their certificates are included in this report on the following pages.

Certificate of Completion

awarded to

Chris Notari

for successfully completing the prescribed course of study in

Pennsylvania Asbestos Building Inspector Refresher Course

under TSCA Title II

presented by

**ACCESS TRAINING SERVICES, INC.
7921 River Road, Pennsauken, NJ 08110
(856) 665-3449**

7/11/19

Course Date

N/A

Exam Date

7/11/20


Expiration Date

Not Provided

Social Security Number

ACC-0719-6-005

Certificate Number

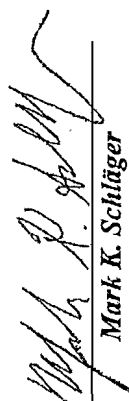
Mark K. Schlager
Training Director

Certificate of Completion

awarded to

Brent M. Tripp

for successfully completing the prescribed course of study in

Pennsylvania Asbestos Building Inspector Refresher Course

under TSCA Title II

presented by

ACCESS TRAINING SERVICES, INC.

7921 River Road, Pennsauken, NJ 08110

(856) 665-3449

7/11/19

Course Date

N/A

Exam Date

7/11/20

Expiration Date

Not Provided

Social Security Number

ACC-0719-6-006

Certificate Number



Mark K. Schlager

Training Director

APPENDIX A

REINSPECTION FINDINGS:

HOMOGENEOUS SAMPLING CHART

RESPONSE ACTION BASED ON HAZARD RANK

ASBESTOS CONTAINING BUILDING MATERIAL (ACBM) LOCATION DRAWINGS

HOMOGENEOUS SAMPLING CHART

Scranton School District Building: West Scranton High School

Dates of Original AHERA Inspection: July, 1988

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HOMOGENEOUS SAMPLING MATERIAL		MATERIAL CATEGORY	ASBESTOS CONTENT	FRIABILITY	AHERA ASSESSMENT	AHERA HAZARD	AHERA REMOVAL PRIORITY	NOTES
MATERIAL LOCATION	MATERIAL DESCRIPTION							
Basement, Unfinished Area	Fittings /Pipe Insulation (Approx. 365 - 400 LF)	TSI SURFACE Misc.	Assumed or Analyzed	F NF-1 NF-2	G D SD	2	6	- Some water damaged areas 10-15 LF. District reported insulation on floor was removed 11/2019
	Corrugated Panels (Approx. 300 - 400 LF)	TSI SURFACE Misc.	Assumed or Analyzed	F NF-1 NF-2	G D SD	3	5	Found associated with metal panels on ceiling
Basement, Fan Room No. 1	Fittings /Pipe Insulation (Approx. 260 - 295 LF)	TSI SURFACE Misc.	Assumed or Analyzed	F NF-1 NF-2	G D SD	3	5	- If fan is in use, all asbestos insulation should be removed
	Transite Panels (Indeterminate) Believed to exist above ductwork	TSI SURFACE Misc.	Assumed or Analyzed	F NF-1 NF-2	G D SD	2	6	
Basement, Maintenance Shop	Ceiling Block (310 SQ FT)	TSI SURFACE Misc.	Assumed or Analyzed	F NF-1 NF-2	G D SD	2	6	This is the only area where blocks tested positive
	Fittings /Pipe Insulation (Approx. 90 - 100 LF)	TSI SURFACE Misc.	Assumed or Analyzed	F NF-1 NF-2	G D SD	2	6	
Basement, Hallway Outside Maintenance Shop	Fittings /Pipe Insulation (Approx. 40 - 45 LF)	TSI SURFACE Misc.	Assumed or Analyzed	F NF-1 NF-2	G D SD	2	6	
	Fittings /Pipe Insulation (Approx. 35 - 40 LF)	TSI SURFACE Misc.	Assumed or Analyzed	F NF-1 NF-2	G D SD	2	6	
Basement, Hallway Corridor "A" & Janitor's Room	Fittings /Pipe Insulation (Approx. 200 - 225 LF)	TSI SURFACE Misc.	Assumed or Analyzed	F NF-1 NF-2	G D SD	2	6	
	Duct Insulation (Approx. 525 - 550 SQ FT)	TSI SURFACE Misc.	Assumed or Analyzed	F NF-1 NF-2	G D SD	4	4	3 SQ FT Damaged, all insulation should be repaired
Basement, Boiler Room	Duct Insulation (Approx. 2,300 - 2,400 SQ FT)	TSI SURFACE Misc.	Assumed or Analyzed	F NF-1 NF-2	G D SD	4	4	
	Breeching (Approx. 450 - 550 SQ FT)	TSI SURFACE Misc.	Assumed or Analyzed	F NF-1 NF-2	G D SD	4	4	
	Fittings /Pipe Insulation (Approx. 825 - 875 LF)	TSI SURFACE Misc.	Assumed or Analyzed	F NF-1 NF-2	G D SD	4	4	7 Large valves above boilers have damage - Approx. 10 fittings and 15 - 20 LF of damaged insulation

Information abstracted by: C Notari & B. Tripp in October, 2019

Friability: F = Friable, NF-1 = Non-Friable, NF-2 = Non-Friable

AHERA Assessment / Hazard Rank / Removal Priority = See Attached Document, "RESPONSE ACTIONS BASED ON HAZARD RANKING"

Building Inspector's Certification No.: 027028-PA & 053975-PA

Assessment: G = Good, D = Damaged, SD = Significantly Damaged

HOMOGENEOUS SAMPLING CHART

Scranton School District Building: West Scranton High School Dates of Original AHERA Inspection: July, 1988 Page 2 of 12

HOMOGENEOUS SAMPLING MATERIAL		MATERIAL CATEGORY	ASBESTOS CONTENT	FRIABILITY	AHERA ASSESSMENT	AHERA HAZARD	AHERA REMOVAL PRIORITY	NOTES
MATERIAL LOCATION	MATERIAL DESCRIPTION							
Basement, Boiler Room	Boiler Insulation (800 - 850 SQ. FT)	TSI SURFACE Misc.	Assumed or Analyzed	F NF-1 NF-2	G D SD	5	3	Two (2) Boilers are decommissioned
	Loose Bags of Asbestos (20 - 30 Bags)	TSI SURFACE Misc.	Assumed or Analyzed	F NF-1 NF-2	G D SD	6	2	- Bags need to be removed immediately. District reported Insulation Bags on floor were removed 11/2019
	Boiler Gaskets (Indeterminate)	TSI SURFACE Misc.	Assumed or Analyzed	F NF-1 NF-2	G D SD	6	2	Remove - Remove Gaskets on decommissioned boilers
Basement, Transformer Room	NOT ACCESSIBLE	TSI SURFACE Misc.	Assumed or Analyzed	F NF-1 NF-2	G D SD	N/A	N/A	Locked & Not Accessible
Basement, Elevator Lobby	Fittings /Pipe Insulation (Approx. 60 - 70 LF)	TSI SURFACE Misc.	Assumed or Analyzed	F NF-1 NF-2	G D SD	2	6	
Basement, Main Corridor	Fittings /Pipe Insulation In Trench (Approx. 40 - 80 LF)	TSI SURFACE Misc.	Assumed or Analyzed	F NF-1 NF-2	G D SD	4	4	Area is inaccessible, amounts and conditions are assumed
	Fittings /Pipe Insulation (Approx. 550 - 575 LF)	TSI SURFACE Misc.	Assumed or Analyzed	F NF-1 NF-2	G D SD	2	6	
Basement, Corridor "B"	Fittings /Pipe Insulation (Approx. 60 - 70 LF)	TSI SURFACE Misc.	Assumed or Analyzed	F NF-1 NF-2	G D SD	2	6	
Basement, Wrestling Room	Fittings /Pipe Insulation (Approx. 10 - 15 LF)	TSI SURFACE Misc.	Assumed or Analyzed	F NF-1 NF-2	G D SD	4	4	Jackets are ripped in many locations
Basement, Fan Room No. 2	Fittings /Pipe Insulation (Approx. 275 - 300 LF)	TSI SURFACE Misc.	Assumed or Analyzed	F NF-1 NF-2	G D SD	2	6	- If fan is in use, all asbestos insulation should be removed
	Corrugated Panels (Approx. 300 - 400 LF)	TSI SURFACE Misc.	Assumed or Analyzed	F NF-1 NF-2	G D SD	3	5	Found associated with metal panels on ceiling
	Transite Panels (Indeterminate) Believed to exist above ductwork	TSI SURFACE Misc.	Assumed or Analyzed	F NF-1 NF-2	G D SD	2	6	

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HOMOGENEOUS SAMPLING CHART

Scranton School District Building: West Scranton High School Dates of Original AHERA Inspection: July, 1988 Page 3 of 12

HOMOGENEOUS SAMPLING MATERIAL		MATERIAL CATEGORY	ASBESTOS CONTENT	FRIABILITY	AHERA ASSESSMENT	AHERA HAZARD	AHERA REMOVAL PRIORITY	NOTES
MATERIAL LOCATION	MATERIAL DESCRIPTION							
Basement, Storage Room "A"	Fittings /Pipe Insulation (Approx. 135 - 150 LF)	TSI SURFACE Misc.	Assumed or Analyzed	F NF-1 NF-2	G D SD	2	6	- Remove damaged fitting
Basement, Athletic Training Room	Fittings /Pipe Insulation (Approx. 10 - 15 LF)	TSI SURFACE Misc.	Assumed or Analyzed	F NF-1 NF-2	N/A	N/A	N/A	- Removed in 2017
Basement, Woodshop Finishing Room No. 1	Fittings /Pipe Insulation (Approx. 1 LF)	TSI SURFACE Misc.	Assumed or Analyzed	F NF-1 NF-2	G D SD	2	6	
Basement, Woodshop Finishing Room No. 2	Fittings /Pipe Insulation (Approx. 35 - 40 LF)	TSI SURFACE Misc.	Assumed or Analyzed	F NF-1 NF-2	G D SD	2	6	
Basement, Woodshop Storage Room "B"	Fittings /Pipe Insulation (Approx. 20 - 30 LF)	TSI SURFACE Misc.	Assumed or Analyzed	F NF-1 NF-2	G D SD	2	6	
Basement, Woodshop	Fittings /Pipe Insulation (Approx. 75 - 100 LF)	TSI SURFACE Misc.	Assumed or Analyzed	F NF-1 NF-2	G D SD	2	6	
Basement, Woodshop Storage Room No. 1	Fittings /Pipe Insulation (Approx. 20 - 25 LF)	TSI SURFACE Misc.	Assumed or Analyzed	F NF-1 NF-2	G D SD	2	6	- Damaged fitting behind cabinet
Basement, Electrical Power / Tech Shop	Fittings /Pipe Insulation (Approx. 150 - 180 LF)	TSI SURFACE Misc.	Assumed or Analyzed	F NF-1 NF-2	G D SD	5	3	Approx. 13 LF of Damage
	Fittings /Pipe Insulation In Trench (Approx. 30 - 35 LF)	TSI SURFACE Misc.	Assumed or Analyzed	F NF-1 NF-2	G D SD	2	6	Area is inaccessible, amounts and conditions are assumed
Basement, Electrical Power / Tech Shop Storage Room "C"	Fittings /Pipe Insulation (Approx. 190 - 230 LF)	TSI SURFACE Misc.	Assumed or Analyzed	F NF-1 NF-2	G D SD	2	6	- Storage Room "C" - Lag open ends of insulation
	Fittings /Pipe Insulation In Trench (Approx. 40 - 50 LF)	TSI SURFACE Misc.	Assumed or Analyzed	F NF-1 NF-2	G D SD	2	6	Area is inaccessible, amounts and conditions are assumed
Basement, Janitors Closets (Near Girls' Locker Room)	Fittings /Pipe Insulation (Approx. 8 - 10 LF)	TSI SURFACE Misc.	Assumed or Analyzed	F NF-1 NF-2	G D SD	2	6	Locked & Not Accessible, amounts and conditions are assumed

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HOMOGENEOUS SAMPLING CHART

Scranton School District Building: West Scranton High School Dates of Original AHERA Inspection: July, 1988 Page 4 of 12

HOMOGENEOUS SAMPLING MATERIAL		MATERIAL CATEGORY	ASBESTOS CONTENT	FRIABILITY	AHERA ASSESSMENT	AHERA HAZARD	AHERA REMOVAL PRIORITY	NOTES
MATERIAL LOCATION	MATERIAL DESCRIPTION							
Basement, Corridor "C"	Fittings /Pipe Insulation (Approx. 190 - 200 LF)	TSI SURFACE Misc.	Assumed or Analyzed	F NF-1 NF-2	G D SD	3	5	3 FT of heavy damage. - Fitting is significantly deteriorating.
Basement, Corridor "C" Trench	Fittings /Pipe Insulation (Approx. 40 - 50 LF)	TSI SURFACE Misc.	Assumed or Analyzed	F NF-1 NF-2	G D SD	2	6	Not Accessible, amounts and conditions are assumed
Basement, Fan Room No. 3	Fittings /Pipe Insulation (Approx. 80 - 90 LF)	TSI SURFACE Misc.	Assumed or Analyzed	F NF-1 NF-2	G D SD	2	6	- If fan is in use, all asbestos insulation should be removed
	Duct Insulation (Approx. 800 - 850 SQ FT)	TSI SURFACE Misc.	Assumed or Analyzed	F NF-1 NF-2	G D SD	2	6	
Basement, Girls' Locker Room and Shower	Fittings /Pipe Insulation (Approx. 320 - 340 LF)	TSI SURFACE Misc.	Assumed or Analyzed	F NF-1 NF-2	G D SD	2	6	
Basement, Girls' Weight Room and Shower	Fittings /Pipe Insulation (Approx. 260 - 290 LF)	TSI SURFACE Misc.	Assumed or Analyzed	F NF-1 NF-2	G D SD	2	6	
Basement, Girls' Coach Office (2 Offices)	Fittings /Pipe Insulation (Approx. 20 - 30 LF)	TSI SURFACE Misc.	Assumed or Analyzed	F NF-1 NF-2	G D SD	2	6	
Basement, Stairwell "E"	Fittings /Pipe Insulation (Approx. 70 - 75 LF)	TSI SURFACE Misc.	Assumed or Analyzed	F NF-1 NF-2	G D SD	2	6	
	Duct Insulation (Approx. 200 - 250 SQ FT)	TSI SURFACE Misc.	Assumed or Analyzed	F NF-1 NF-2	G D SD	2	6	
Basement, Stairwell "E" Trench	Fittings /Pipe Insulation (Approx. 10 - 15 LF)	TSI SURFACE Misc.	Assumed or Analyzed	F NF-1 NF-2	G D SD	2	6	Not Accessible, amounts and conditions are assumed
Basement, Women's Restroom	Fittings /Pipe Insulation (Approx. 30 - 35 LF)	TSI SURFACE Misc.	Assumed or Analyzed	F NF-1 NF-2	G D SD	2	6	
Basement, Corridor "D"	Fittings /Pipe Insulation (Approx. 80 - 95 LF)	TSI SURFACE Misc.	Assumed or Analyzed	F NF-1 NF-2	G D SD	2	6	

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HOMOGENEOUS SAMPLING CHART

Scranton School District Building: West Scranton High School Dates of Original AHERA Inspection: July, 1988 Page 5 of 12

HOMOGENEOUS SAMPLING MATERIAL		MATERIAL CATEGORY	ASBESTOS CONTENT	FRIABILITY	AHERA ASSESSMENT	AHERA HAZARD	AHERA REMOVAL PRIORITY	NOTES
MATERIAL LOCATION	MATERIAL DESCRIPTION							
Basement, Stage Storage / Prop Storage #1 and #2	Fittings /Pipe Insulation (Approx. 235 - 260 LF)	TSI SURFACE Misc.	Assumed or Analyzed	F NF-1 NF-2	G D SD	3	5	
Basement, Stage Storage #1	Duct Insulation (Approx. 1,800 - 1,900 SQ.FT)	TSI SURFACE Misc.	Assumed or Analyzed	F NF-1 NF-2	G D SD	6	2	Significant damage to insulation, needs to be removed
Basement, Corridor "E"	Fittings /Pipe Insulation (Approx. 160 - 170 LF)	TSI SURFACE Misc.	Assumed or Analyzed	F NF-1 NF-2	G D SD	2	6	
Basement, Coaches Offices (2)	Fittings /Pipe Insulation (Approx. 30 - 40 LF)	TSI SURFACE Misc.	Assumed or Analyzed	F NF-1 NF-2	G D SD	2	6	Locked & Not Accessible, amounts and conditions are assumed
Basement, Boys' Locker Room and Showers No.1	Fittings /Pipe Insulation (Approx. 225 - 250 LF)	TSI SURFACE Misc.	Assumed or Analyzed	F NF-1 NF-2	G D SD	3	5	10 - 15 LF of damaged insulation in shower area
Basement, Physical Ed. Training Room & Storage	Fittings /Pipe Insulation (Approx. 30 - 40 LF)	TSI SURFACE Misc.	Assumed or Analyzed	F NF-1 NF-2	G D SD	2	6	Locked & Not Accessible, amounts and conditions are assumed
Basement, Boys' Locker Room No. 2 and Shower	Fittings /Pipe Insulation (Approx. 195 - 215 LF)	TSI SURFACE Misc.	Assumed or Analyzed	F NF-1 NF-2	G D SD	2	6	
Basement, Stairwell "F"	Fittings /Pipe Insulation (Approx. 140 - 150 LF)	TSI SURFACE Misc.	Assumed or Analyzed	F NF-1 NF-2	G D SD	2	6	
Basement, Boys' Weight Room / Side Rooms / Play Room	Fittings /Pipe Insulation (Approx. 300 - 360 LF)	TSI SURFACE Misc.	Assumed or Analyzed	F NF-1 NF-2	G D SD	2	6	
1st Floor, Room 122	Fittings /Pipe Insulation (Approx. 12 LF)	TSI SURFACE Misc.	Assumed or Analyzed	F NF-1 NF-2	G D SD	2	6	
1st Floor, Guidance Room 121	Fittings /Pipe Insulation (Approx. 12 LF)	TSI SURFACE Misc.	Assumed or Analyzed	F NF-1 NF-2	G D SD	2	6	
1st Floor, Room 118	Fittings /Pipe Insulation (Approx. 12 LF)	TSI SURFACE Misc.	Assumed or Analyzed	F NF-1 NF-2	G D SD	2	6	

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HOMOGENEOUS SAMPLING CHART

Scranton School District Building: West Scranton High School Dates of Original AHERA Inspection: July, 1988 Page 6 of 12

HOMOGENEOUS SAMPLING MATERIAL		MATERIAL CATEGORY	ASBESTOS CONTENT	FRIABILITY	AHERA ASSESSMENT	AHERA HAZARD	AHERA REMOVAL PRIORITY	NOTES
MATERIAL LOCATION	MATERIAL DESCRIPTION							
1st Floor, Room 119 Chemistry Lab	Fittings /Pipe Insulation (Approx. 12 LF)	TSI SURFACE Misc.	Assumed or Analyzed	F NF-1 NF-2	G D SD	2	6	
	Lab Tables (Approx. 135 - 145 LF)	TSI SURFACE Misc.	Assumed or Analyzed	F NF-1 NF-2	G D SD	2	6	One table has cracks throughout middle of table
1st Floor, Room 120	Fittings /Pipe Insulation (Approx. 12 LF)	TSI SURFACE Misc.	Assumed or Analyzed	F NF-1 NF-2	G D SD	2	6	
	9 x 9 Floor Tile & Mastic (Approx. 1,080 SQ FT)	TSI SURFACE Misc.	Assumed or Analyzed	F NF-1 NF-2	G D SD	4	4	4 SQ FT of missing floor tiles, Moderate cracking throughout, Mastic Assumed.
	Asbestos Fire Blanket in classroom (Indeterminate)	TSI SURFACE Misc.	Assumed or Analyzed	F NF-1 NF-2	N/A	N/A	N/A	- Blanket in metal canister was not found. No documentation provided by district
	Acoustical Plaster Ceiling (Approx. 1,400 - 1,800 SQ FT)	TSI SURFACE Misc.	Assumed or Analyzed	F NF-1 NF-2	G D SD	4	4	- Damage from lights attached to ceiling. Ceiling not be disturbed.
1st Floor, Band Storage Room	Fittings /Pipe Insulation (Approx. 12 - 15 LF)	TSI SURFACE Misc.	Assumed or Analyzed	F NF-1 NF-2	G D SD	2	6	
1st Floor, Rooms 126, 127, 128, 129	Fittings /Pipe Insulation (Approx. 12 LF per room)	TSI SURFACE Misc.	Assumed or Analyzed	F NF-1 NF-2	G D SD	2	6	
1st Floor, Rooms 130, Medical Room	Fittings /Pipe Insulation (Approx. 15 LF)	TSI SURFACE Misc.	Assumed or Analyzed	F NF-1 NF-2	G D SD	2	6	
	Linoleum and Mastic (Approx. 720 SQ FT)	TSI SURFACE Misc.	Assumed or Analyzed	F NF-1 NF-2	G D SD	2	6	Mastic Assumed
1st Floor, Auditorium (All Levels)	Acoustical Plaster Ceiling (Approx. 10,320 SQ FT)	TSI SURFACE Misc.	Assumed or Analyzed	F NF-1 NF-2	G D SD	2	6	
1st Floor, Auditorium and Staircase "F"	Floor Tile (varies in size) & Mastic (Approx. 1,650 SQ FT)	TSI SURFACE Misc.	Assumed or Analyzed	F NF-1 NF-2	G D SD	5	3	

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HOMOGENEOUS SAMPLING CHART

Scranton School District Building: West Scranton High School Dates of Original AHERA Inspection: July, 1988 Page 7 of 12

HOMOGENEOUS SAMPLING MATERIAL		MATERIAL CATEGORY	ASBESTOS CONTENT	FRIABILITY	AHERA ASSESSMENT	AHERA HAZARD	AHERA REMOVAL PRIORITY	NOTES
MATERIAL LOCATION	MATERIAL DESCRIPTION							
1st Floor, Outside Hallway Girls' Restrooms	Fittings /Pipe Insulation (Approx. 60 LF)	TSI SURFACE Misc.	Assumed or Analyzed	F NF-1 NF-2	G D SD	5	3	Approx. 6" of insulation has been crushed
1st Floor, Girls' Restroom Chase in Room 130 A	Fittings /Pipe Insulation (Approx. 50 - 60 LF)	TSI SURFACE Misc.	Assumed or Analyzed	F NF-1 NF-2	G D SD	4	4	6 - 8 LF has been damaged
1st Floor, Rooms 100, 101, and 105	Fittings /Pipe Insulation (Approx. 12 LF per room)	TSI SURFACE Misc.	Assumed or Analyzed	F NF-1 NF-2	G D SD	2	6	- Repair insulation in Room 105 at bottom
1st Floor, Rooms 100, 101, and 103	Acoustical Plaster Ceiling (Approx. 690 SQ FT per room)	TSI SURFACE Misc.	Assumed or Analyzed	F NF-1 NF-2	G D SD	4	4	- Room 103, Minor cracking - Damage from lights being attached to ceiling
1st Floor, Rooms 102, 104, 106, and 107	Fittings /Pipe Insulation (Approx. 12 LF per room)	TSI SURFACE Misc.	Assumed or Analyzed	F NF-1 NF-2	G D SD	5	3	- Repair insulation in Room 102, Minor puncture holes
1st Floor, Boys' Restroom (Next to Room 106)	Fittings /Pipe Insulation (Approx. 50 - 60 LF)	TSI SURFACE Misc.	Assumed or Analyzed	F NF-1 NF-2	G D SD	6	2	- 25 LF of water damaged insulation. - Insulation should be removed
1st Floor, English Department Office	Corrugated Paper Panels (Approx. 50 - 60 LF)	TSI SURFACE Misc.	Assumed or Analyzed	F NF-1 NF-2	G D SD	6	2	- Panels appear to be layered between floor chases and have heavy damage
1st Floor, Rooms 108, 109, and 112	Fittings /Pipe Insulation (Approx. 12 LF per room)	TSI SURFACE Misc.	Assumed or Analyzed	F NF-1 NF-2	G D SD	2	6	- Room 108, 112, Repair minor damage
1st Floor, Women's Teachers' Lounge	12" X 12" Floor Tile & Mastic (Approx. 380 SQ FT)	TSI SURFACE Misc.	Assumed or Analyzed	F NF-1 NF-2	G D SD	2	6	Mastic Assumed
1st Floor, Room 114	Fittings /Pipe Insulation (Approx. 12 LF)	TSI SURFACE Misc.	Assumed or Analyzed	F NF-1 NF-2	G D SD	2	6	
	9" X 9" Floor Tile & Mastic (Approx. 690 SQ FT)	TSI SURFACE Misc.	Assumed or Analyzed	F NF-1 NF-2	G D SD	2	6	9"X9" under rug Mastic Assumed

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HOMOGENEOUS SAMPLING CHART

Scranton School District Building: West Scranton High School Dates of Original AHERA Inspection: July, 1988 Page 8 of 12

HOMOGENEOUS SAMPLING MATERIAL		MATERIAL CATEGORY	ASBESTOS CONTENT	FRIABILITY	AHERA ASSESSMENT	AHERA HAZARD	AHERA REMOVAL PRIORITY	NOTES
MATERIAL LOCATION	MATERIAL DESCRIPTION							
1st Floor, Main Office, Principals Office, and Closet	9" X 9" Floor Tile & Mastic (Approx. 1,380 SQ.FT.)	TSI SURFACE Misc.	Assumed or Analyzed	F NF-1 NF-2	G D SD	2	6	- Replace missing floor tiles at entrance to copy room, Floor tile under carpet, Mastic Assumed
1st Floor, Main Office, Principals Office, and Closet	Fittings /Pipe Insulation (Approx. 10 - 15 LF)	TSI SURFACE Misc.	Assumed or Analyzed	F NF-1 NF-2	G D SD	2	6	
1st Floor, Men's Teachers' Lounge	12" X 12" Floor Tile & Mastic (Approx. 380 SQ.FT.)	TSI SURFACE Misc.	Assumed or Analyzed	F NF-1 NF-2	G D SD	2	6	Mastic Assumed
	Fittings /Pipe Insulation (Approx. 12 LF)	TSI SURFACE Misc.	Assumed or Analyzed	F NF-1 NF-2	G D SD	2	6	
1st Floor, Room 117	Fittings /Pipe Insulation (Approx. 24 - 30 LF)	TSI SURFACE Misc.	Assumed or Analyzed	F NF-1 NF-2	G D SD	2	6	
1st Floor, Room 115	Fittings /Pipe Insulation (Approx. 12 LF)	TSI SURFACE Misc.	Assumed or Analyzed	F NF-1 NF-2	G D SD	2	6	
2nd Floor, Girl's Restroom No.2	Fittings /Pipe Insulation (Approx. 12 LF)	TSI SURFACE Misc.	Assumed or Analyzed	F NF-1 NF-2	G D SD	2	6	Locked & Not Accessible, amounts and conditions are assumed
2nd Floor, Girl's Restroom Chase in Room 233	Fittings /Pipe Insulation (Approx. 2 - 3 LF)	TSI SURFACE Misc.	Assumed or Analyzed	F NF-1 NF-2	G D SD	2	6	
2nd Floor, Room 233	9" X 9" Floor Tile & Mastic (Approx. 420 SQ.FT.)	TSI SURFACE Misc.	Assumed or Analyzed	F NF-1 NF-2	G D SD	3	5	
2nd Floor, Room 202	12" X 12" Floor Tile & Mastic (Approx. 920 SQ.FT.)	TSI SURFACE Misc.	Assumed or Analyzed	F NF-1 NF-2	G D SD	4	4	1- 8 SQ.FT of damaged floor tiles. - Possible multiple layers of floor tile. - Mastic Assumed - Tiles are deteriorating
	Fittings /Pipe Insulation (Approx. 12 LF)	TSI SURFACE Misc.	Assumed or Analyzed	F NF-1 NF-2	G D SD	2	6	
2nd Floor, Rooms 203, 204, 205, 207, 208, 209, 210, 211, 212, 213, 214, 216, 217, and 218	Fittings /Pipe Insulation (Approx. 12 LF per room)	TSI SURFACE Misc.	Assumed or Analyzed	F NF-1 NF-2	G D SD	2	6	- Room 207, 1 LF of insulation needs repair. - Room 213 is Not Accessible, amounts and conditions are assumed.

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HOMOGENEOUS SAMPLING CHART

Scranton School District Building: West Scranton High School Dates of Original AHERA Inspection: July, 1988 Page 9 of 12

HOMOGENEOUS SAMPLING MATERIAL		MATERIAL CATEGORY	ASBESTOS CONTENT	FRIABILITY	AHERA ASSESSMENT	AHERA HAZARD	AHERA REMOVAL PRIORITY	NOTES
MATERIAL LOCATION	MATERIAL DESCRIPTION							
2nd Floor, Room 206 Home Economics	Fittings /Pipe Insulation (Approx. 12 LF)	TSI SURFACE Misc.	Assumed or Analyzed	F NF-1 NF-2	G D SD	5	3	- 4 SQ FT of insulation is damaged. - Linoleum in room tested Negative for asbestos.
2nd Floor, Janitors Closet No. 2 (Across from room 208)	Fittings /Pipe Insulation (Approx. 25 - 30 LF)	TSI SURFACE Misc.	Assumed or Analyzed	F NF-1 NF-2	G D SD	4	4	4 - 6 LF of damaged insulation
2nd Floor, Boys' Restroom No. 2 and Chase	Fittings /Pipe Insulation (Approx. 25 - 30 LF)	TSI SURFACE Misc.	Assumed or Analyzed	F NF-1 NF-2	G D SD	2	6	- Chase - Remove Significantly damaged debris. Insulation on Floor
2nd Floor, Library (Rm 213A) & Library Office	Fittings /Pipe Insulation (Approx. 24 LF)	TSI SURFACE Misc.	Assumed or Analyzed	F NF-1 NF-2	G D SD	2	6	
2nd Floor, Room 215 and 215A	Fittings /Pipe Insulation (Approx. 25 - 30 LF)	TSI SURFACE Misc.	Assumed or Analyzed	F NF-1 NF-2	G D SD	2	6	
2nd Floor, Girls' Restrooms No. 1 and Chase	Fittings /Pipe Insulation (Approx. 15 - 30 LF)	TSI SURFACE Misc.	Assumed or Analyzed	F NF-1 NF-2	G D SD	2	6	Locked & Not Accessible, amounts and conditions are assumed
2nd Floor, Rooms 219, 220, 222, and 223	Fittings /Pipe Insulation (Approx. 12 LF per room)	TSI SURFACE Misc.	Assumed or Analyzed	F NF-1 NF-2	G D SD	2	6	- Room 220 - Enclose Pipe - Room 223 - Enclose Pipe
2nd Floor, Boys' Restroom	Fittings /Pipe Insulation (Approx. 12 LF per room)	TSI SURFACE Misc.	Assumed or Analyzed	F NF-1 NF-2	G D SD	2	6	
2nd Floor, Janitors' Closet No.1 (across from Room 225)	Fittings /Pipe Insulation (Approx. 18 LF)	TSI SURFACE Misc.	Assumed or Analyzed	F NF-1 NF-2	G D SD	7	1	- Remove
2nd Floor, Rooms 228, 229, 230, and 231	Fittings /Pipe Insulation (Approx. 12 LF per room)	TSI SURFACE Misc.	Assumed or Analyzed	F NF-1 NF-2	G D SD	2	6	
2nd Floor, Room 232	Fittings /Pipe Insulation (Approx. 20 - 30 LF)	TSI SURFACE Misc.	Assumed or Analyzed	F NF-1 NF-2	G D SD	2	6	Locked & Not Accessible, amounts and conditions are assumed
3rd Floor, Cafeteria	Fittings /Pipe Insulation (Approx. 100 - 125 LF)	TSI SURFACE Misc.	Assumed or Analyzed	F NF-1 NF-2	G D SD	2	6	
	Acoustical Plaster Ceiling (Approx. 4,900 SQ FT)	TSI SURFACE Misc.	Assumed or Analyzed	F NF-1 NF-2	G D SD	3	5	Lights are attached to ceiling, Interior Partition attached to ceiling, and TV Monitors attached to ceiling

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HOMOGENEOUS SAMPLING CHART

Scranton School District Building: West Scranton High School Dates of Original AHERA Inspection: July, 1988 Page 10 of 12

HOMOGENEOUS SAMPLING MATERIAL		MATERIAL CATEGORY	ASBESTOS CONTENT	FRIABILITY	AHERA ASSESSMENT	AHERA HAZARD	AHERA REMOVAL PRIORITY	NOTES
MATERIAL LOCATION	MATERIAL DESCRIPTION							
3rd Floor, Cafeteria Kitchen	Fittings /Pipe Insulation (Approx. 20 - 30 LF)	TSI SURFACE Misc.	Assumed or Analyzed	F NF-1 NF-2	G D SD	2	6	- Floor Tile starting to deteriorate. - Mastic Assumed.
	9" X 9" Floor Tile & Mastic (Approx. 1,100 SQ FT)	TSI SURFACE Misc.	Assumed or Analyzed	F NF-1 NF-2	G D SD	4	4	- Floor Tile appears to be painted Gray
3rd Floor, Room 301 District Gifted Office	9" X 9" Floor Tile & Mastic (Approx. 512 SQ FT)	TSI SURFACE Misc.	Assumed or Analyzed	F NF-1 NF-2	G D SD	2	6	Mastic Assumed
	Fittings /Pipe Insulation (Approx. 12 LF)	TSI SURFACE Misc.	Assumed or Analyzed	F NF-1 NF-2	G D SD	2	6	
3rd Floor, Girls' Restrooms No. 2 and Chase	Fittings /Pipe Insulation (Approx. 20 - 25 LF)	TSI SURFACE Misc.	Assumed or Analyzed	F NF-1 NF-2	G D SD	2	6	
	Fittings /Pipe Insulation (Approx. 20 - 25 LF)	TSI SURFACE Misc.	Assumed or Analyzed	F NF-1 NF-2	G D SD	2	6	
3rd Floor, Rooms 302, 304, 305, 307, 308, 309, 310, 312, 315, 316, 318, 319, 321, and 324	Fittings /Pipe Insulation (Approx. 12 LF per room)	TSI SURFACE Misc.	Assumed or Analyzed	F NF-1 NF-2	G D SD	2	6	- Room 309 - Repair - Co-op Office - Repair Base - Room 321 - Repair - Room 323 - Repair Base
	Fittings /Pipe Insulation (Approx. 24 LF)	TSI SURFACE Misc.	Assumed or Analyzed	F NF-1 NF-2	G D SD	2	6	
3rd Floor, Janitors' Closet No.2 (across from Room 310)	Fittings /Pipe Insulation (Approx. 45 - 50 LF)	TSI SURFACE Misc.	Assumed or Analyzed	F NF-1 NF-2	G D SD	4	4	- Loose debris on floor. Insulation has heavy deterioration
	Fittings /Pipe Insulation (Approx. 15 - 30 LF)	TSI SURFACE Misc.	Assumed or Analyzed	F NF-1 NF-2	G D SD	2	6	- Remove Loose debris in chase
3rd Floor, Girls' Restrooms No. 2	Fittings /Pipe Insulation (Approx. 12 LF)	TSI SURFACE Misc.	Assumed or Analyzed	F NF-1 NF-2	G D SD	2	6	
	Fittings /Pipe Insulation (Approx. 12 LF per room)	TSI SURFACE Misc.	Assumed or Analyzed	F NF-1 NF-2	G D SD	2	6	- Room 329, Small puncture holes in insulation

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HOMOGENEOUS SAMPLING CHART

Scranton School District Building: West Scranton High School Dates of Original AHRA Inspection: July, 1988 Page 11 of 12

HOMOGENEOUS SAMPLING MATERIAL		MATERIAL CATEGORY	ASBESTOS CONTENT	FRIABILITY	AHRA ASSESSMENT	AHRA HAZARD	AHRA REMOVAL PRIORITY	NOTES
MATERIAL LOCATION	MATERIAL DESCRIPTION							
3rd Floor, Room 329	Lab Tables (Approx. 30 LF)	TSI SURFACE Misc.	Assumed or Analyzed	F NF-1 NF-2	G D SD	2	6	
3rd Floor, Kitchen Office	9" X 9" Floor Tile & Mastic (Approx. 310 SQ FT)	TSI SURFACE Misc.	Assumed or Analyzed	F NF-1 NF-2	G D SD	2	6	Mastic Assumed
3rd Floor, Storage Area off Cafeteria	Fittings /Pipe Insulation (Approx. 30 - 40 LF)	TSI SURFACE Misc.	Assumed or Analyzed	F NF-1 NF-2	G D SD	2	6	
3rd Floor, Room 319	Transite Panels (Approx. 10 SQ FT)	TSI SURFACE Misc.	Assumed or Analyzed	F NF-1 NF-2	G D SD	2	6	
Attic and Penthouse	Fittings /Pipe Insulation (Approx. 3,000 - 4,000 LF)	TSI	Assumed	F	G			RESTRICT ACCESS / REMOVE - Intact insulation generally in good condition - Abated material found in approx. 20 - 25 bags. These bags need to be removed immediately. - It was reported that multiple piles of loose asbestos debris was removed in the winter of 2017. - Addition loose debris still exist in attic area. The District reported loose debris on floor was removed 11/2019 - Thoroughly clean up of area. - Blown in insulation was added since last inspection, unknown if debris and damaged items were repaired or removed
		SURFACE	or	NF-1	D	5	3	
		Misc.	Analyzed	NF-2	SD			
Throughout Building	Mastic Glue Mastic Behind Chalkboards	TSI SURFACE Misc.	Assumed or Analyzed	F NF-1 NF-2	G D SD	1	7	
	Sink Coating on Exterior Base of Sinks	TSI SURFACE Misc.	Assumed or Analyzed	F NF-1 NF-2	G D SD	2	6	
	Ductwork Flex Connections (Indeterminate)	TSI SURFACE Misc.	Assumed or Analyzed	F NF-1 NF-2	G D SD	1	7	
	Vapor Barriers (Indeterminate)	TSI SURFACE Misc.	Assumed or Analyzed	F NF-1 NF-2	G D SD	1	7	Vapor barriers were observed in some restroom areas.

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Building Inspector's Certification No.: 027028-PA & 053975-PA

Page 12 of 12


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AAHERA Assessment / Hazard Rank / Removal Priority = See Attached Document, "RESPONSE ACTIONS BASED ON HAZARD RANKING"

RESPONSE ACTIONS BASED ON HAZARD RANK

HAZARD RANK	REMOVAL PRIORITY	AHERA CATEGORIES	RESPONSE ACTIONS REQUIRED BY AHERA
7	1	Significantly Damaged	Evacuate or restrict the area if needed. Remove the ACBM (or enclose or encapsulate it if sufficient to contain fibers). Repair of T.S.I. allowed if feasible and safe. O&M required for all ACBM.
6	2	Damaged with Potential for Significant Damaged	Evacuate or restrict the area if needed. Remove, enclose, encapsulate, or repair to correct damage. Take steps to reduce potential for disturbance. O&M required for all ACBM.
5	3	Damaged with Potential for Damage	Remove, enclose, encapsulate, or repair to correct damage. O&M required for all ACBM.
4	4	Damaged with Low Potential for Damage	Remove, enclose, encapsulate, or repair to correct damage. O&M required for all ACBM.
3	5	Good with Potential for Significant Damage	Evacuate or restrict the area if needed. Take steps to reduce potential for disturbance. O&M required for all ACBM.
2	6	Good with Potential For Damage	O&M required for all ACBM. Take steps to reduce potential for damage.
1	7	Good with Low Potential for Disturbance	O&M required for all ACBM

BASEMENT PLAN
NOT TO SCALE

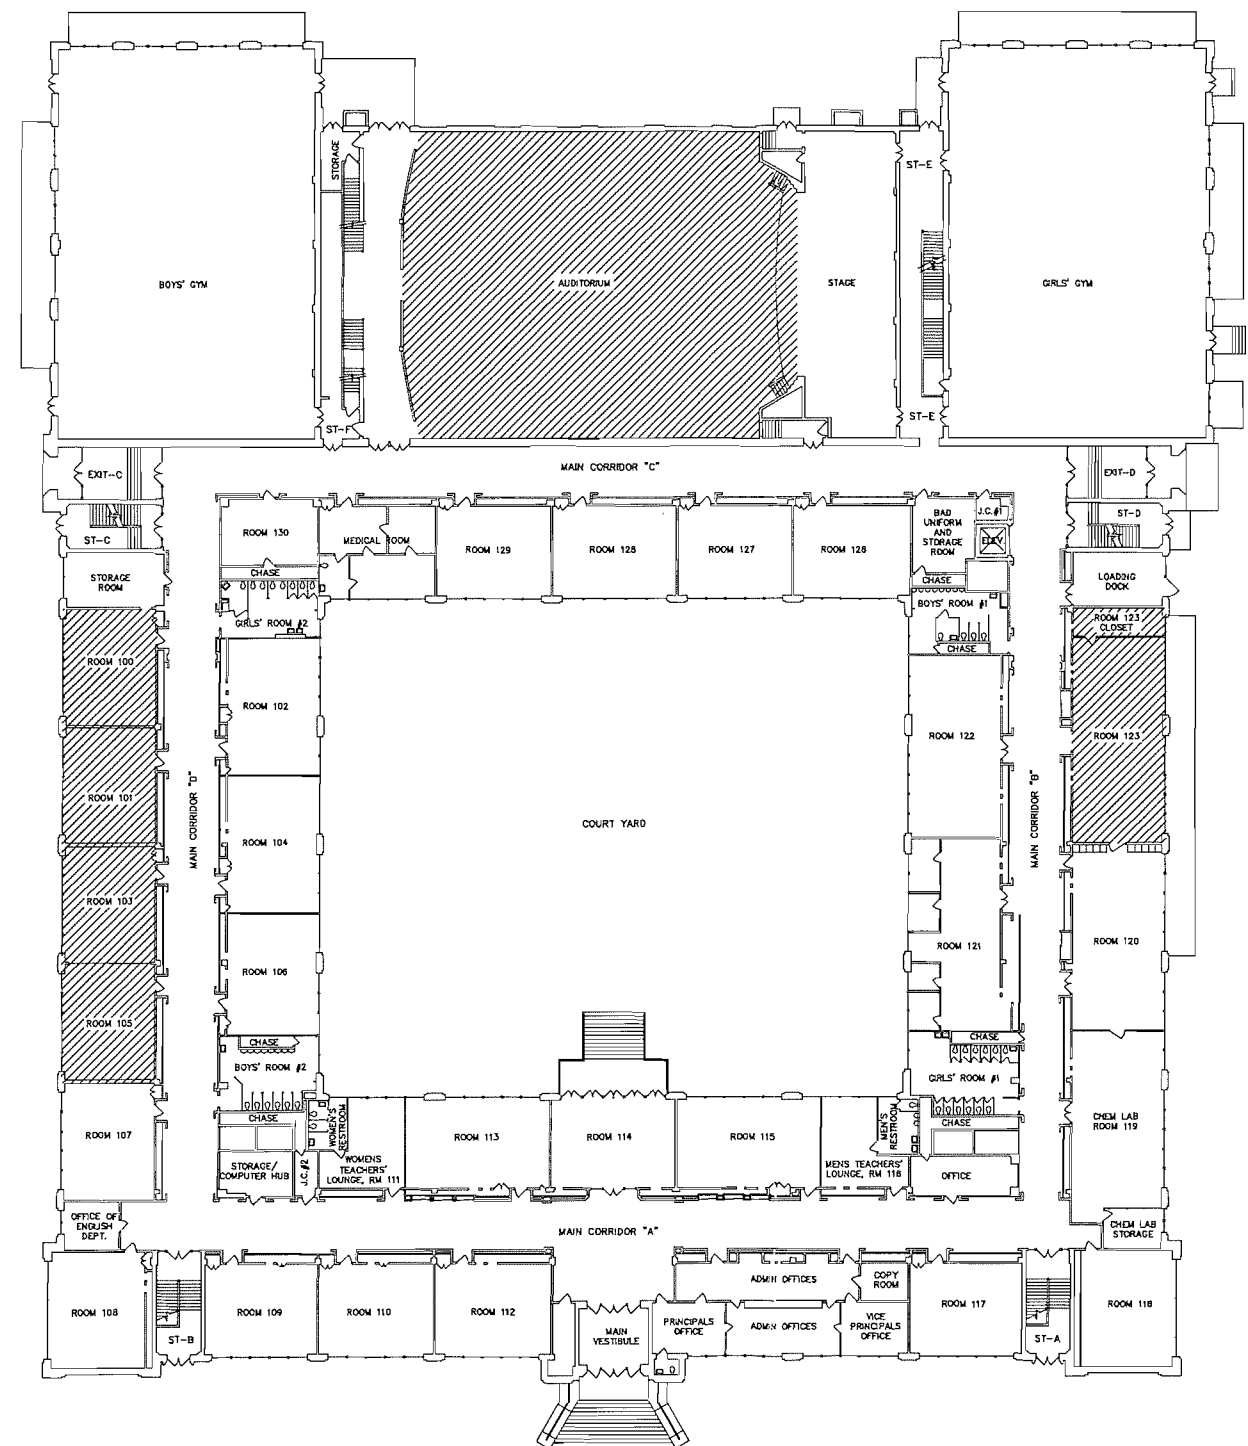


1ST FLOOR PLAN
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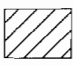
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DRAWING No.:
A
1

SURFACING ASBESTOS CONTAINING MATERIALS




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 ACOUSTICAL PLASTER CEILING

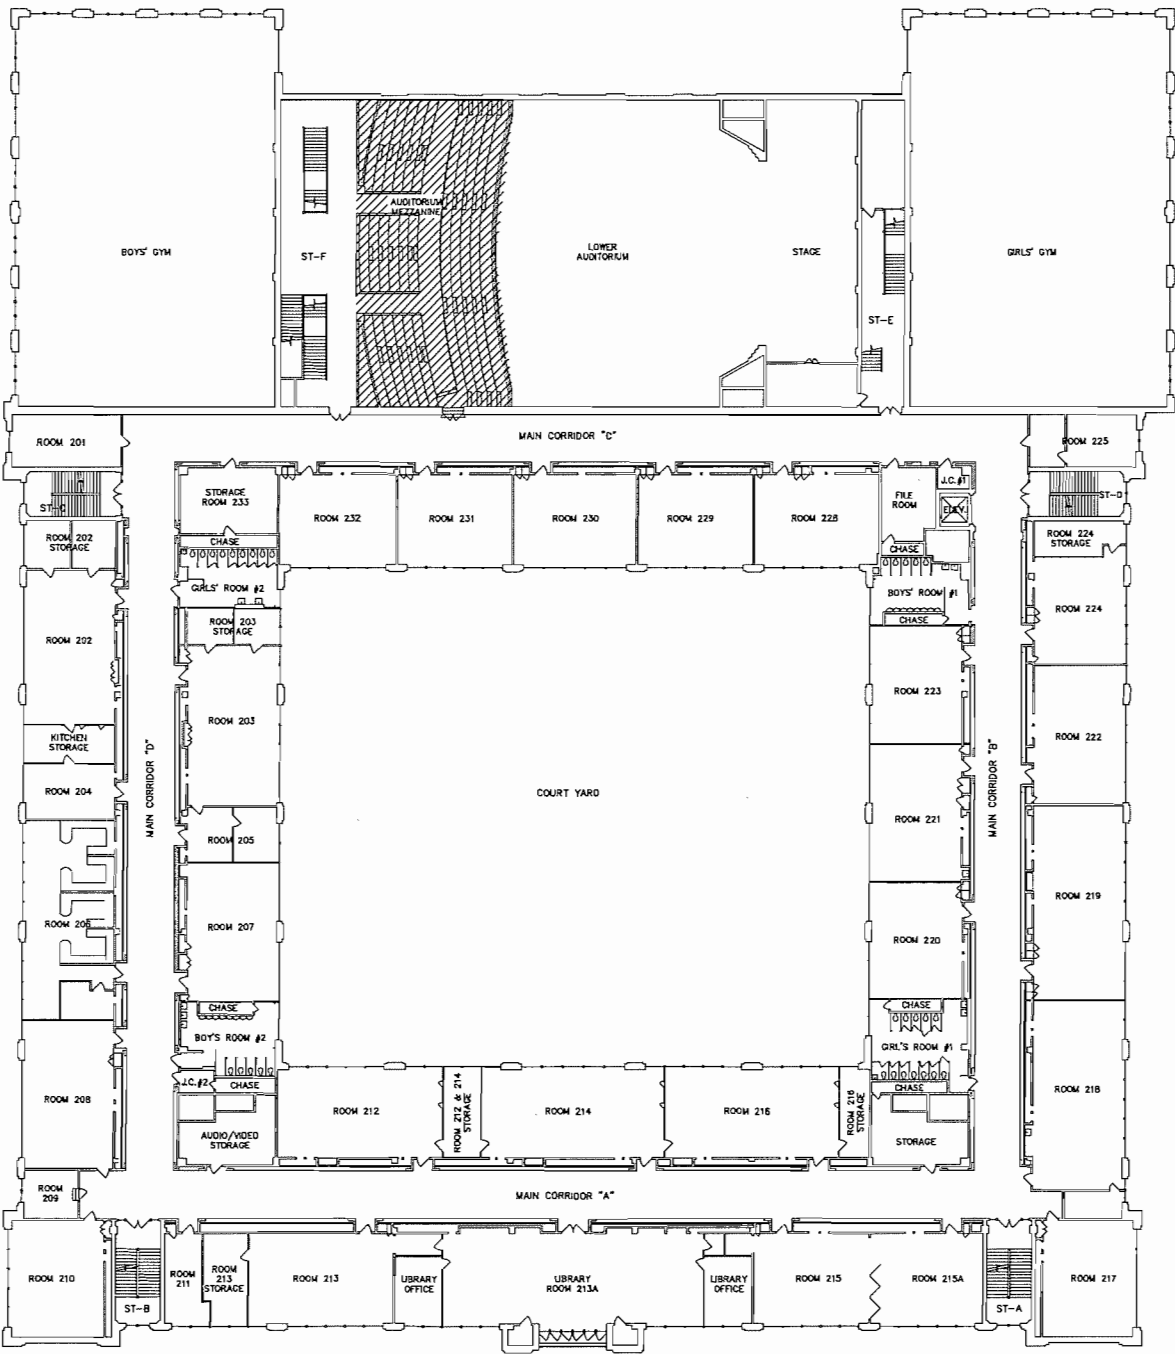
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- EXTERIOR COATING ON SINKS

2ND FLOOR PLAN
NOT TO SCALE



KEY - SURFACING ACM

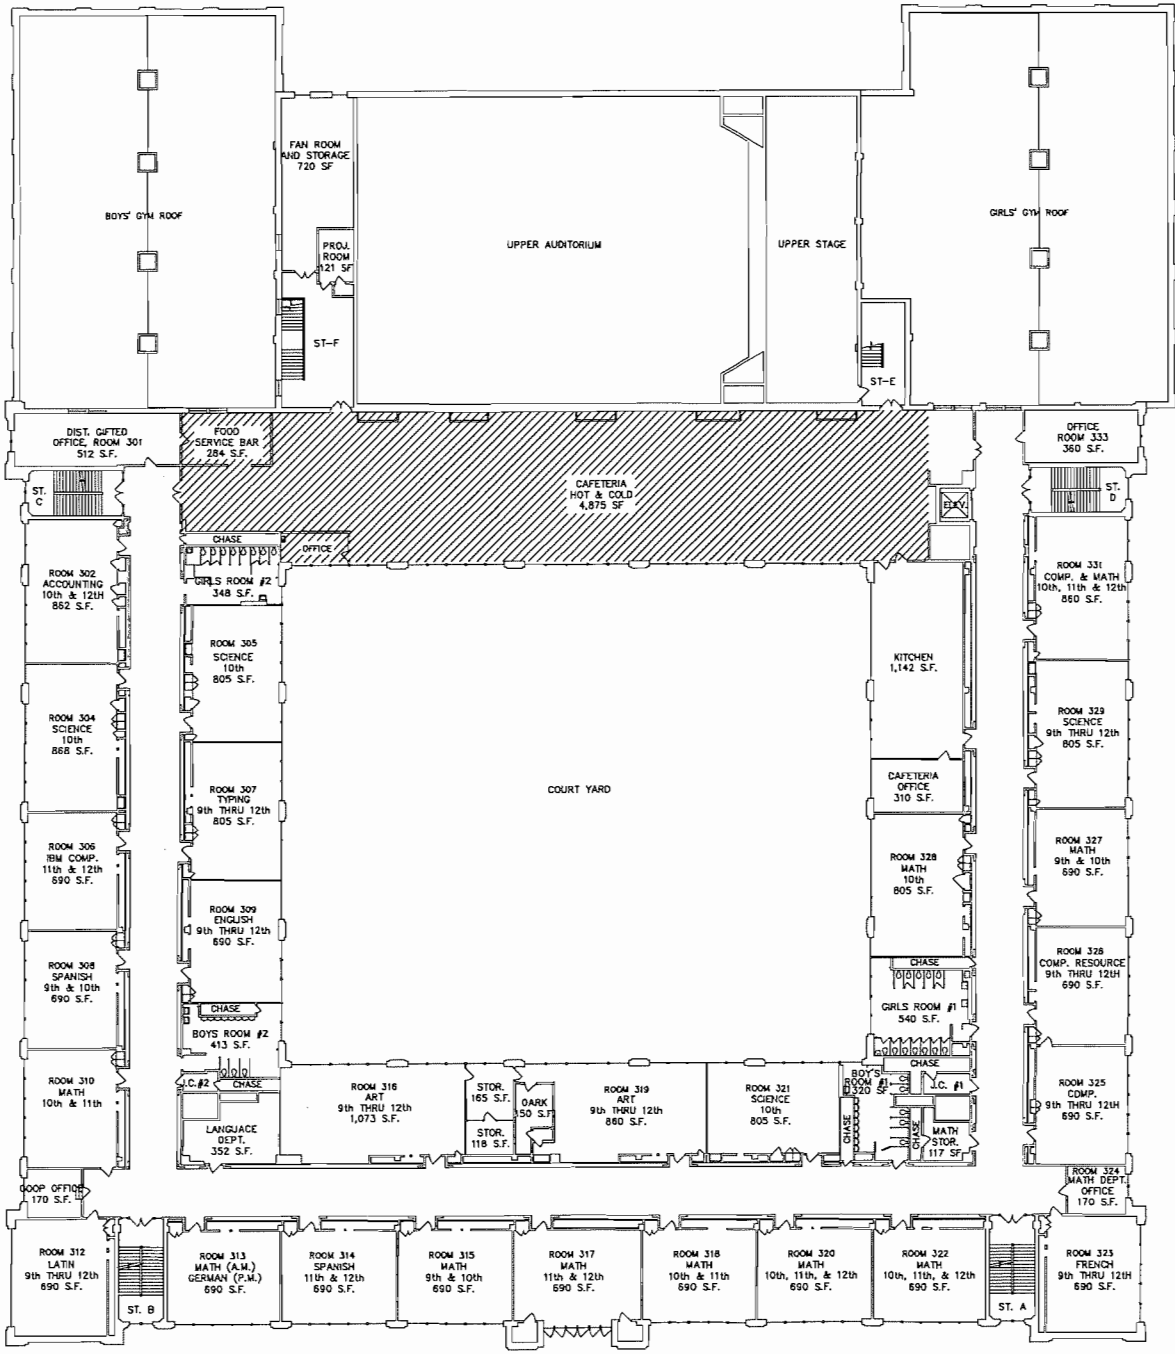 ACOUSTICAL PLASTER CEILING

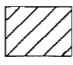ASSUMED ASBESTOS CONTAINING SURFACING MATERIAL:

- EXTERIOR COATING ON SINKS

3RD FLOOR PLAN
NOT TO SCALE

Scranton School District
Scranton School District
425 North Washington Avenue
Scranton, PA 18505

Asbestos Management Plans

Guzek Associates, Inc.
Mechanical, Electrical, Structural,
Environmental, and Architectural
Engineering
401 Derts Street
Clarks Summit, PA 18411
Phone: (570) 586-9700
Fax: (570) 586-6728
E-Mail: guzekassoc@aol.com

DRAWN BY: BMT
CHECKED BY: CN
JOB No.: SSD 19-751
SCALE: AS NOTED
DATE: 10/02/2019


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ISSUED or REVISED

DATE

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2**


SURFACING ASBESTOS CONTAINING MATERIALS

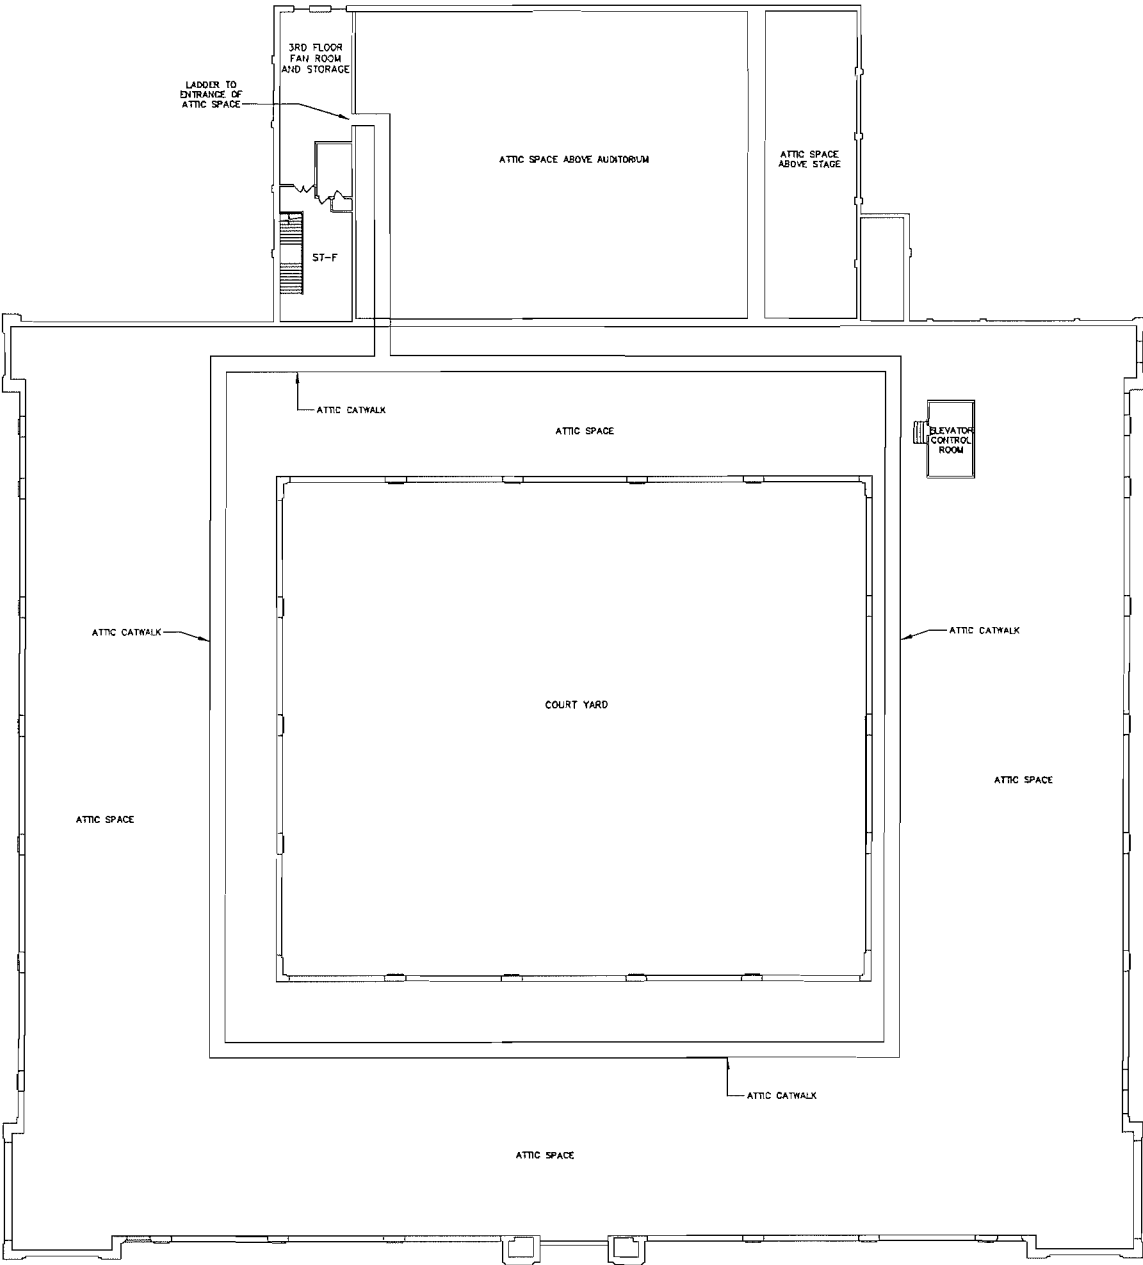

KEY — SURFACING ACM
ASBESTOS CONTAINING
SURFACING MATERIALS WERE
NOT FOUND ON THIS LEVEL

ATTIC PLAN
NOT TO SCALE

Sheet Size: 36"x24"

**Guzek Associates[™]**
Mechanical, Electrical, Structural,
Environmental, and Architectural
Engineering
401 Davis Street
Clark Summit, PA 18411
Phone: (370) 586-9700
Fax: (370) 586-6728
E-Mail: guzekassoc@aol.com

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SCALE: AS NOTED
DATE: 10/02/2019

OWC TITLE: 2019 WEST SCRANTON HIGH SCHOOL FLOOR PLANS


ISSUED or REVISED	DATE

Scranton School District
Scranton School District
425 North Washington Avenue
Scranton, PA 18505

Asbestos Management Plans

DRAWING No.:
**A
3**


THERMAL ASBESTOS CONTAINING MATERIALS

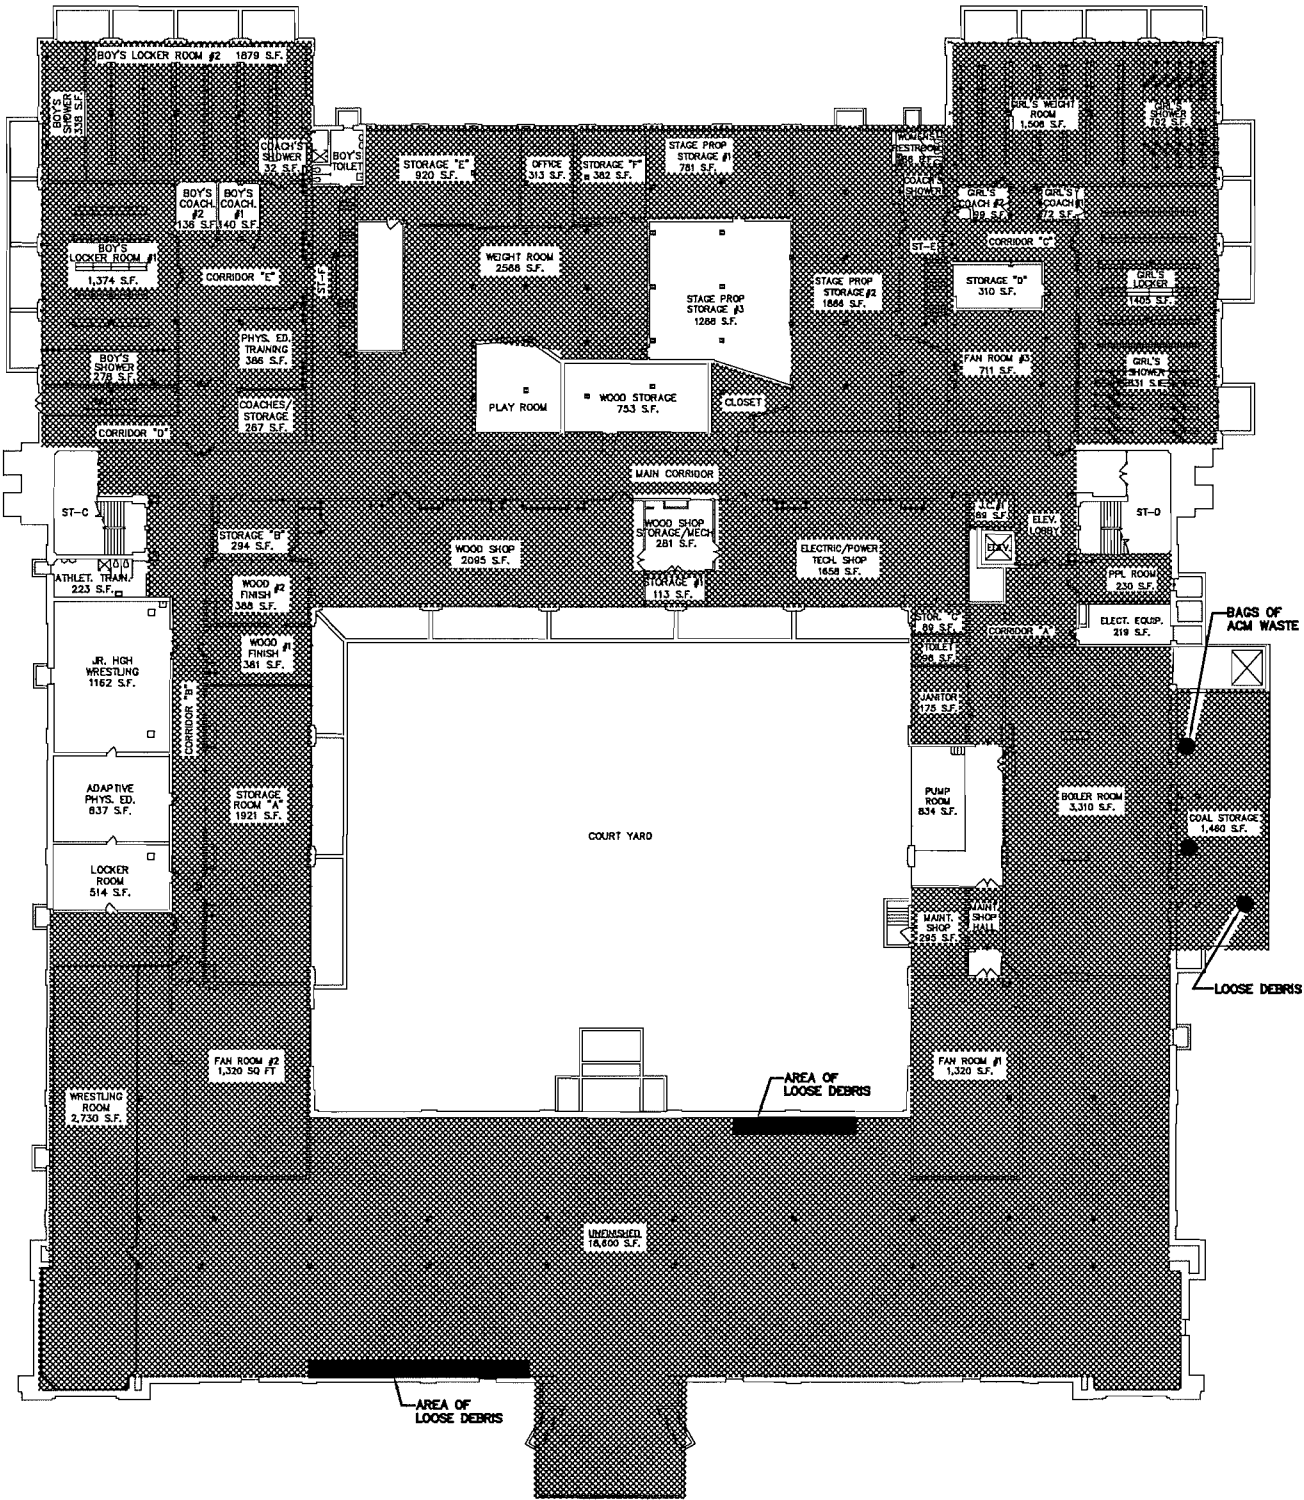

KEY — THERMAL ACM

FITTINGS, PIPE INSULATION, AND DUCT INSULATION

BASEMENT PLAN
NOT TO SCALE

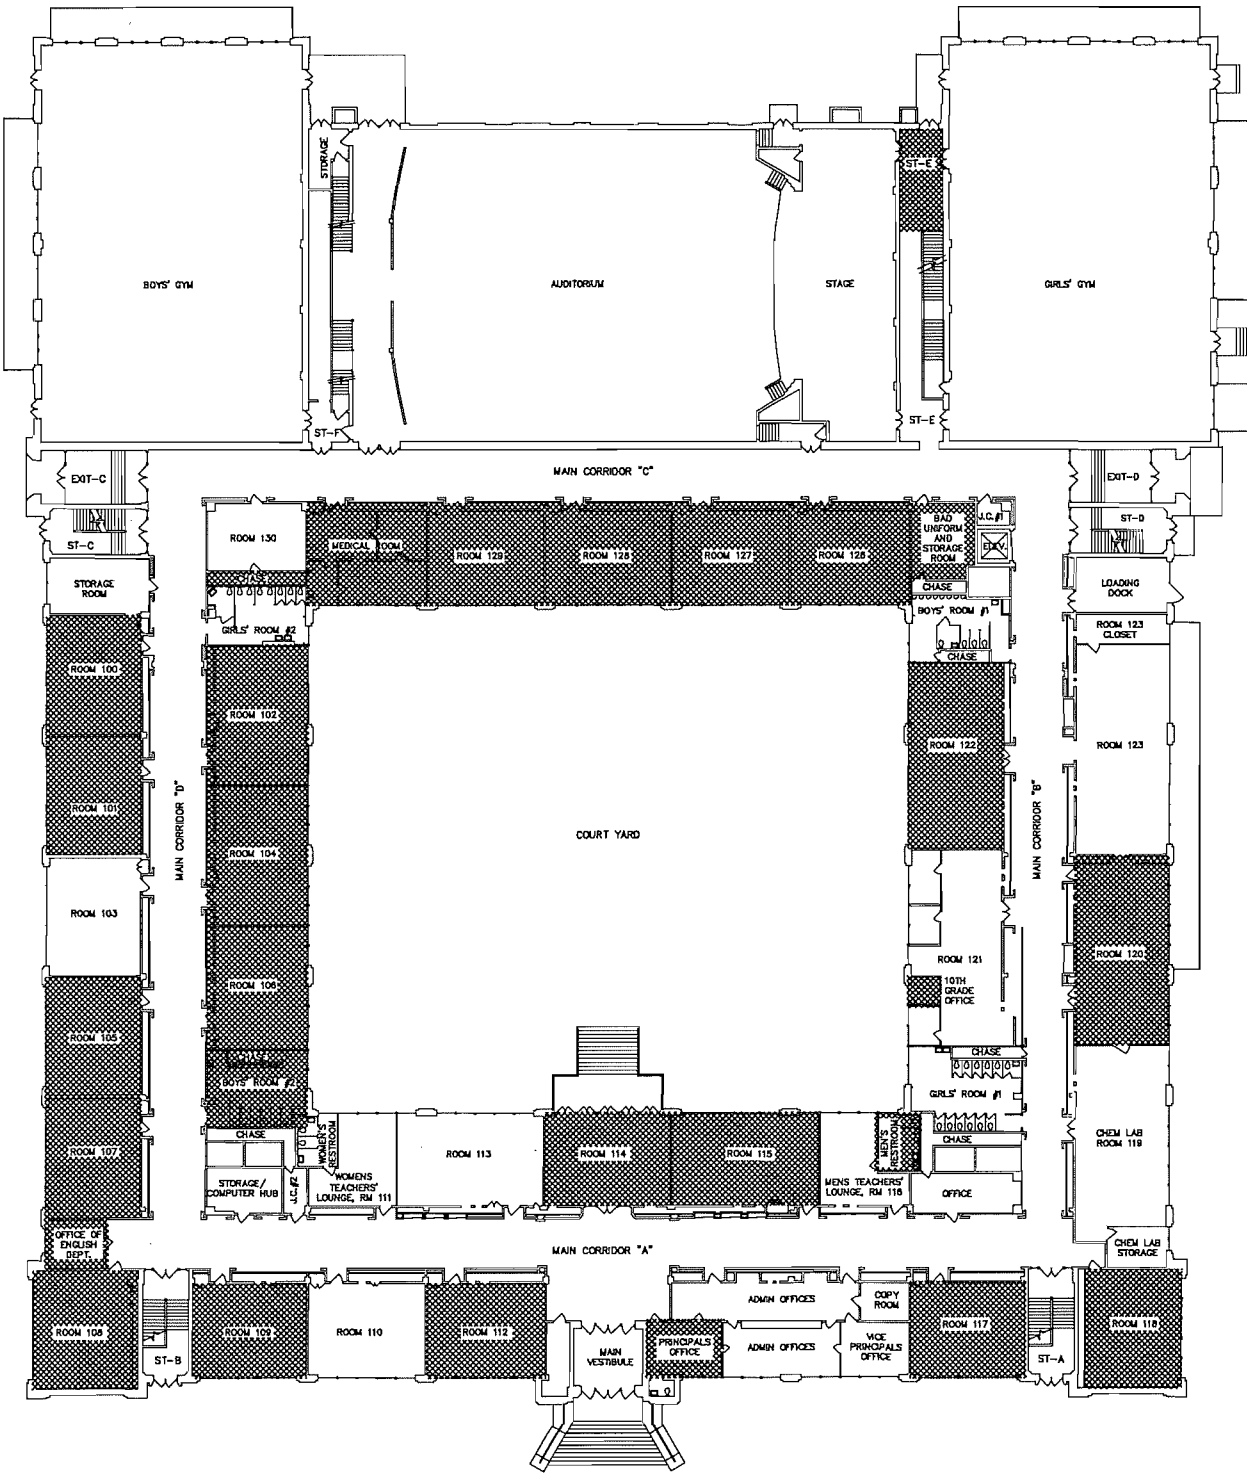

KEY — THERMAL ACM

FITTINGS, PIPE INSULATION, AND DUCT INSULATION

1ST FLOOR PLAN
NOT TO SCALE

Guzek Associates, Inc.
Mechanical, Electrical, Structural,
Environmental, and Architectural
Engineering
401 Davis Street
Scranton, PA 18411
Phone: (717) 386-9700
Fax: (717) 386-4728
E-Mail: guz@guzek.com

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DATE

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DATE:

SCALE:

AS NOTED

DATE:

DWG. TITLE:

2019 WEST SCRANTON HIGH SCHOOL FLOOR PLANS

Scranton School District
Scranton School District
425 North Washington Avenue
Scranton, PA 18505

Asbestos Management Plans

DRAWING No.:

A

4

SECOND FLOOR

BOYS' GYM

ST-F

AUDITORIUM

MEZZANINE

LOWER AUDITORIUM

STAGE

ST-E

GIRLS' GYM

MAIN CORRIDOR "C"

ROOM 201

ST-H

ROOM 202 STORAGE

ROOM 202

KITCHEN STORAGE

ROOM 204

ROOM 205

ROOM 206

ROOM 207

ROOM 208

ST-B

ROOM 210

ROOM 211

ROOM 212 STORAGE

ROOM 213

LIBRARY OFFICE

LIBRARY ROOM 213A

LIBRARY OFFICE

ROOM 215

ROOM 215A

ST-A

ROOM 217

ROOM 218

ROOM 219

ROOM 220

CHASE

ROOM 221

ROOM 222

CHASE

ROOM 223

CHASE

BOYS' ROOM #1

FILE ROOM

ST-C

ROOM 224 STORAGE

ROOM 224

BOYS' ROOM #2

ROOM 225

ST-D

COURT YARD

MAIN CORRIDOR "D"

STORAGE ROOM 233

ROOM 232

ROOM 231

ROOM 230

ROOM 229

ROOM 228

ROOM 203 STORAGE

ROOM 203

ROOM 206

ROOM 207

CHASE

BOYS' ROOM #2

ROOM 212 & 214 STORAGE

ROOM 212

ROOM 214

ROOM 216

STORAGE

CHASE

ROOM 218

CHASE

ROOM 220

CHASE

ROOM 222

CHASE

ROOM 224

CHASE

ROOM 226

CHASE

ROOM 228

CHASE

ROOM 230

CHASE

ROOM 232

CHASE

ROOM 234

CHASE

ROOM 236

CHASE

ROOM 238

CHASE

ROOM 240

CHASE

ROOM 242

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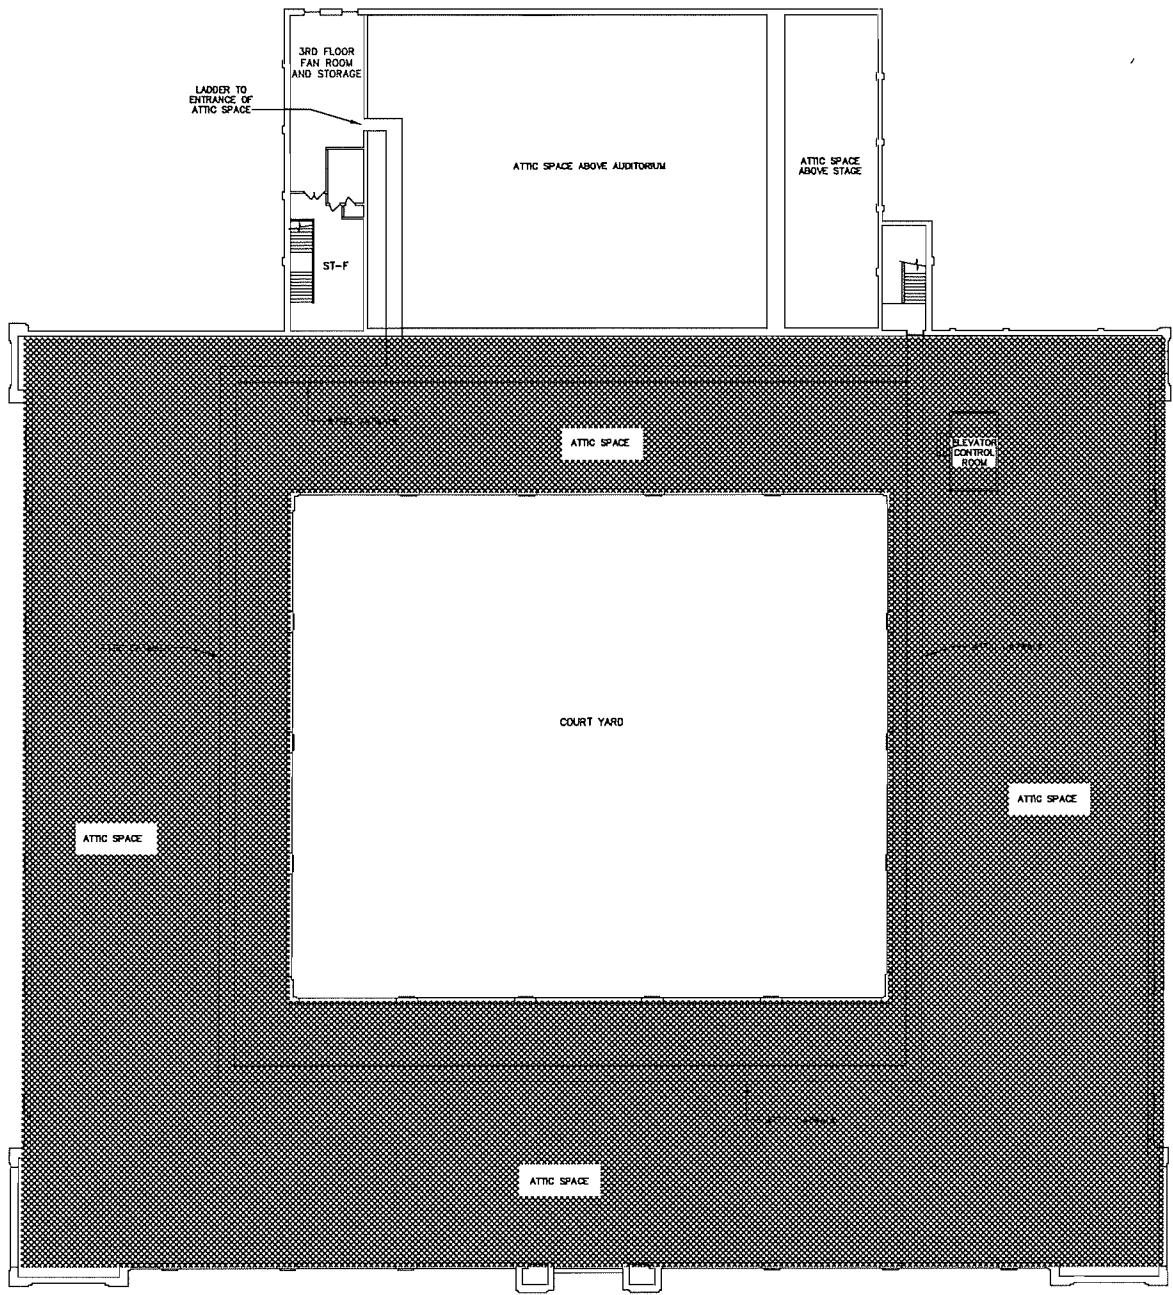
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ROOM 550

CHASE

[illegible]**ACM LOCATIONS: 2019**

THERMAL ASBESTOS CONTAINING MATERIALS



KEY — THERMAL ACM

FITTINGS, PIPE
INSULATION, AND
DUCT INSULATION

ATTIC PLAN
NOT TO SCALE

Sheet Size: 36"x24"

Scranton School District
Scranton School District
425 North Washington Avenue
Scranton, PA 18505

Asbestos Management Plans

DRAWING No.:
A6

ACM LOCATIONS: 2019

Guzek Associates, Inc.
401 Davis Street
Clark Summit, NJ 07411
Phone: (770) 586-9700
Fax: (770) 586-6728
E-Mail: guzekassoc@aol.com

DRAWN BY: BMT

CHECKED BY: CN

JOB No.: SSD 19_751

SCALE: AS NOTED


DATE: 10/02/2019

DWG. TITLE: 2019 WEST SCRANTON HIGH SCHOOL FLOOR PLANS

Mechanical, Electrical, Structural,
Environmental, and Architectural
Engineering

[illegible]

NOT TO SCALE


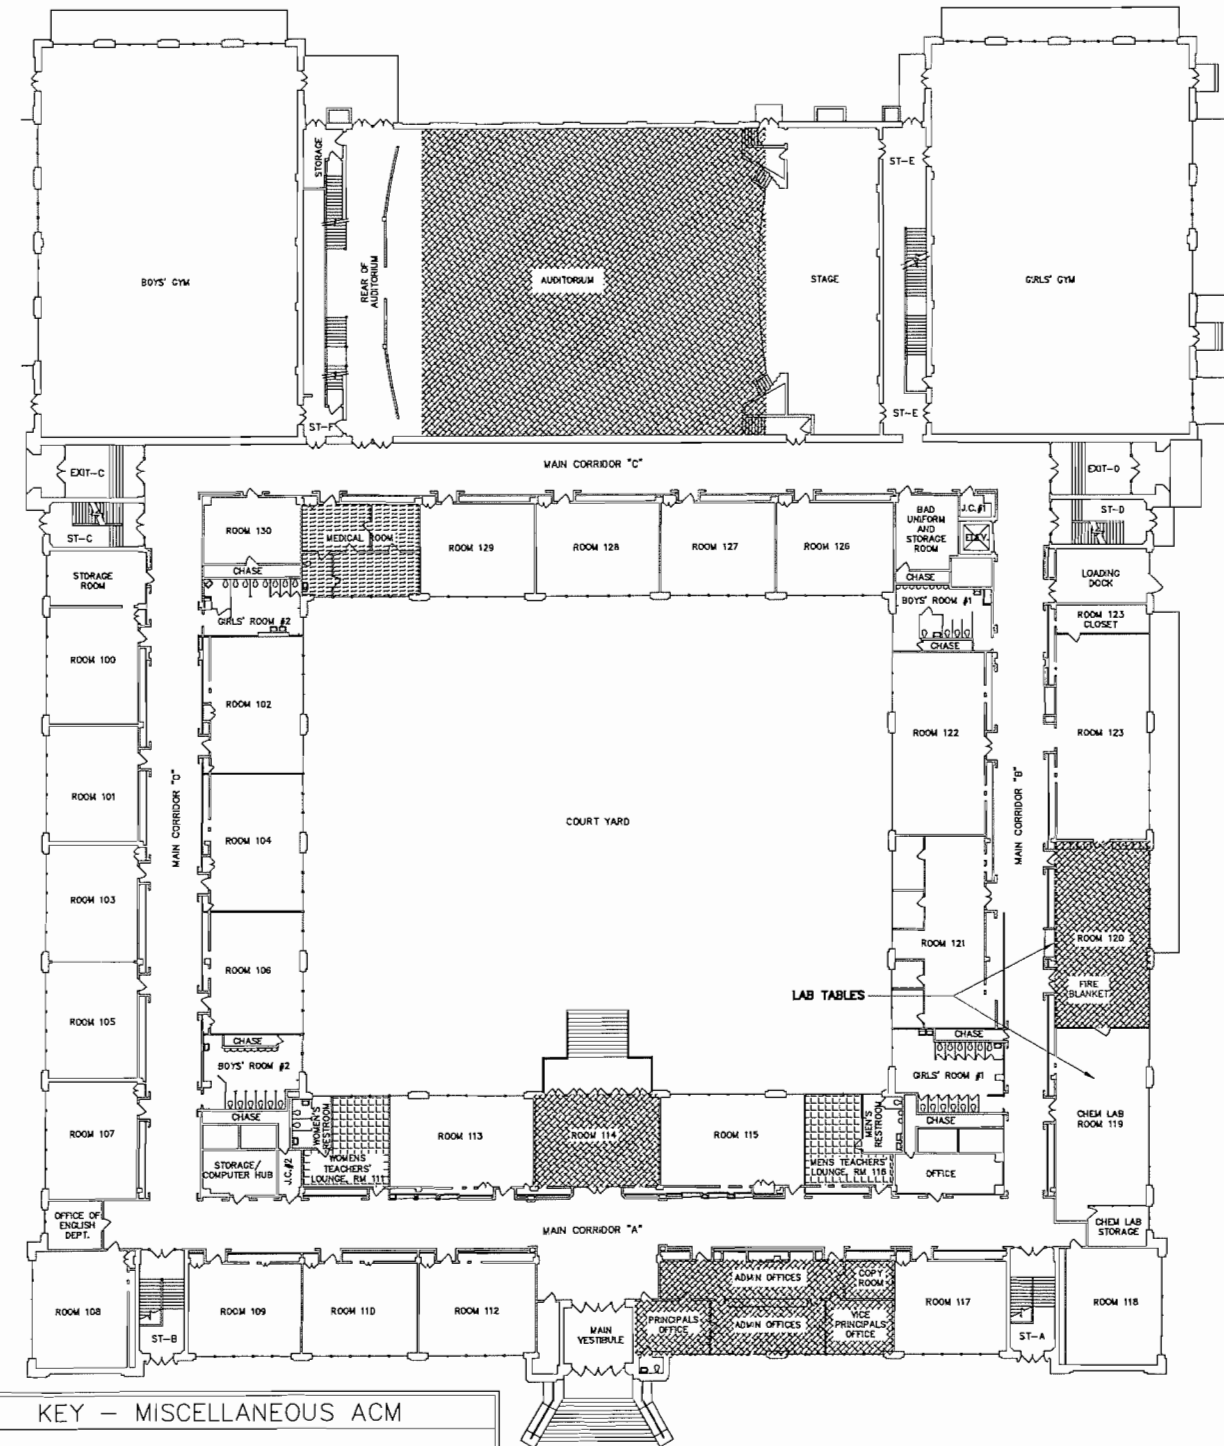


NOT TO SCALE

DRAWING No.:
A
7

ACM LOCATIONS: 2019

MISCELLANEOUS ASBESTOS CONTAINING MATERIALS

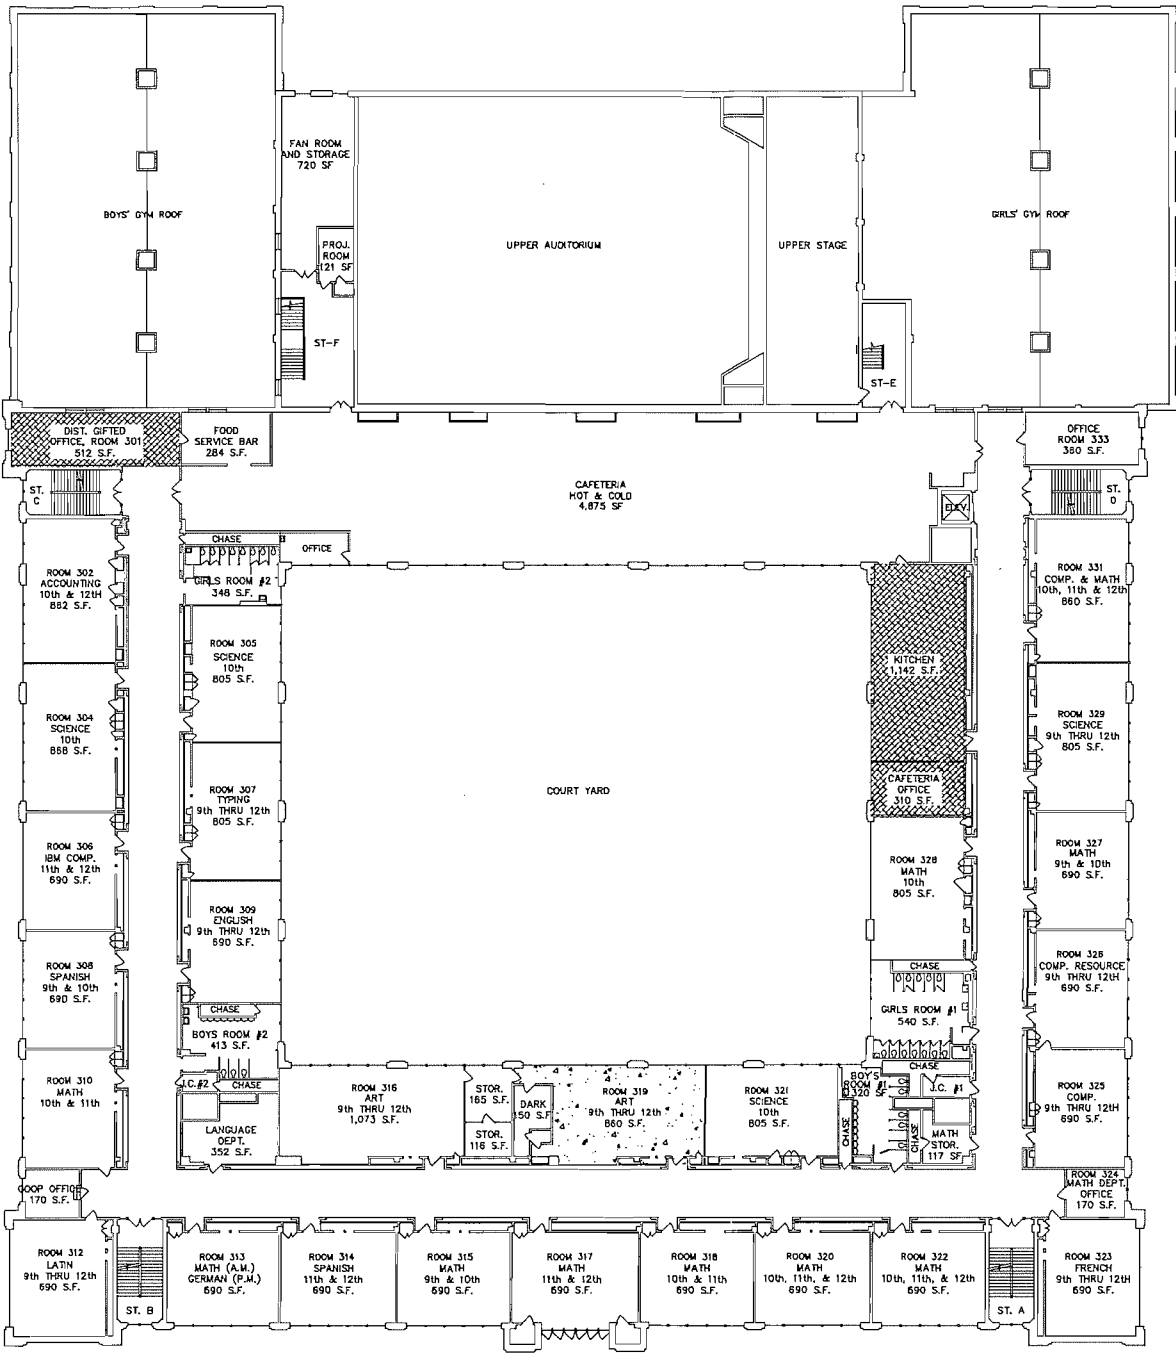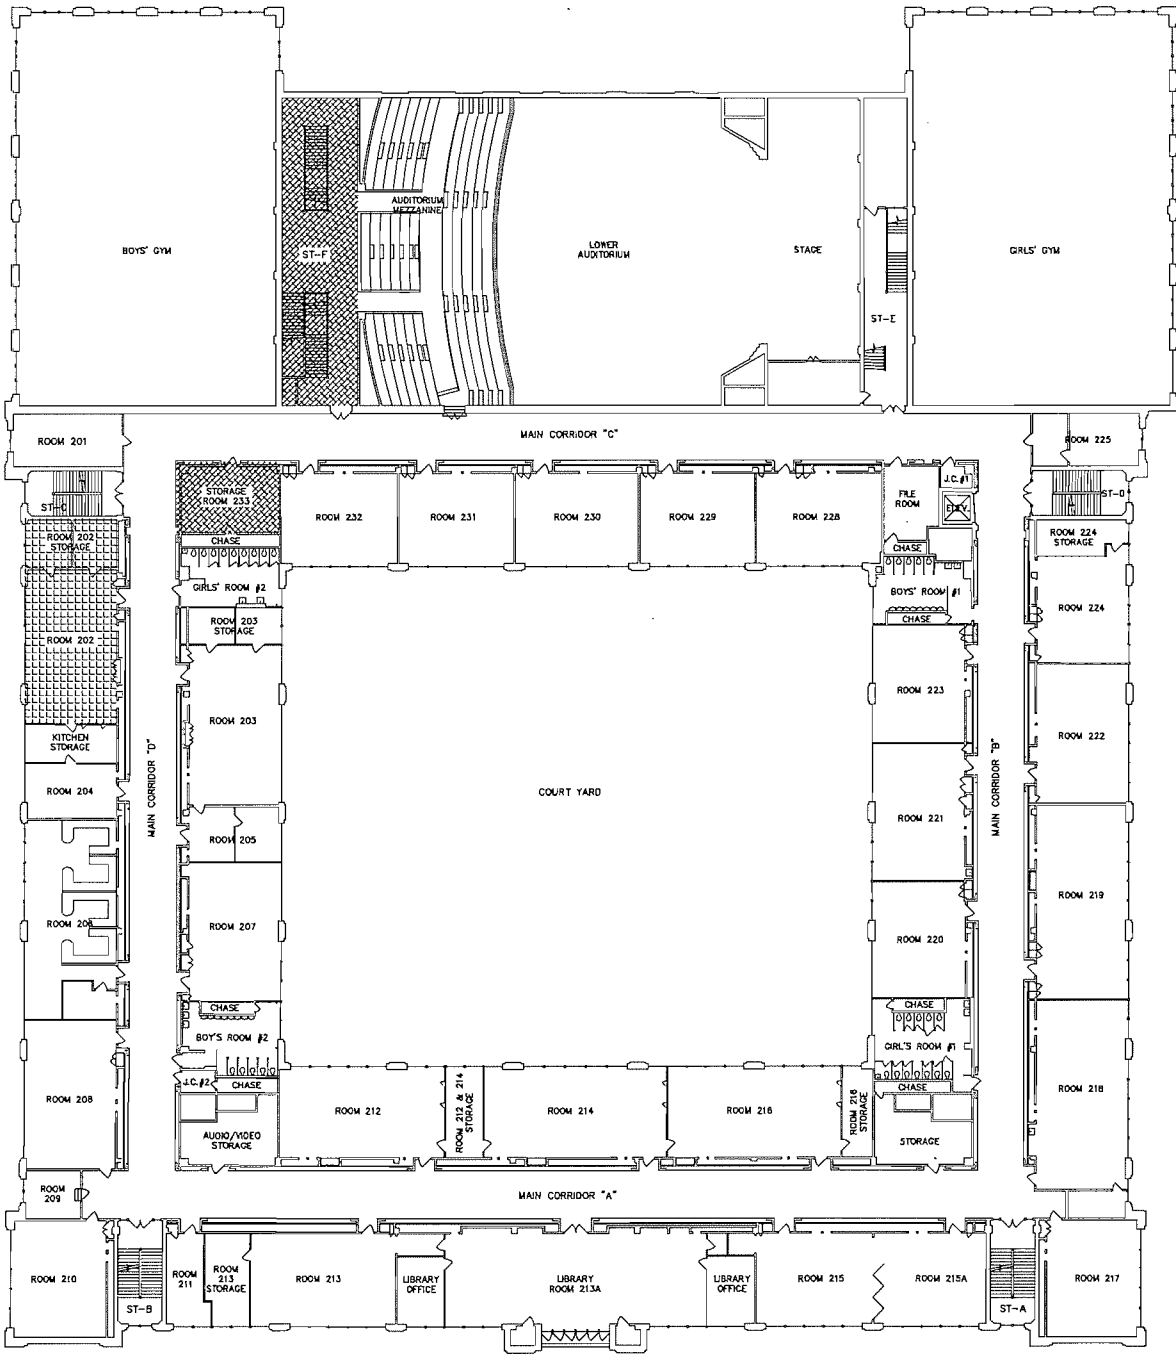

KEY - MISCELLANEOUS ACM

9"x9" FLOOR TILE AND MASTIC

12"x12" FLOOR TILE AND MASTIC

ASSUMED ASBESTOS CONTAINING MISCELLANEOUS MATERIAL:

- CHALKBOARD AND WALLBOARD MASTIC
- DUCTWORK FLEX CONNECTION

2ND FLOOR PLAN
NOT TO SCALE

KEY - MISCELLANEOUS ACM

9"x9" FLOOR TILE AND MASTIC

TRANSITE PANEL

ASSUMED ASBESTOS CONTAINING MISCELLANEOUS MATERIAL:

- CHALKBOARD AND WALLBOARD MASTIC
- DUCTWORK FLEX CONNECTION

3RD FLOOR PLAN
NOT TO SCALE

Scranton School District
Scranton School District
425 North Washington Avenue
Scranton, PA 18505

Asbestos Management Plans

Guzek Associates, Inc.
Mechanical, Electrical, Structural, Environmental, and Architectural Engineering
401 Dardis Street
Clarks Summit, PA 18411
Phone: (570) 586-9700
Fax: (570) 586-6728
E-Mail: guzekassoc@aol.com


DRAWN BY: BMT
CHECKED BY: CN
JOB No.: SSD 19-751
SCALE: AS NOTED
DATE: 10/02/2019

DWG. TITLE: 2019 WEST SCRANTON HIGH SCHOOL FLOOR PLANS

ISSUED or REVISED DATE

DRAWING No.: A

MISCELLANEOUS ASBESTOS CONTAINING MATERIALS

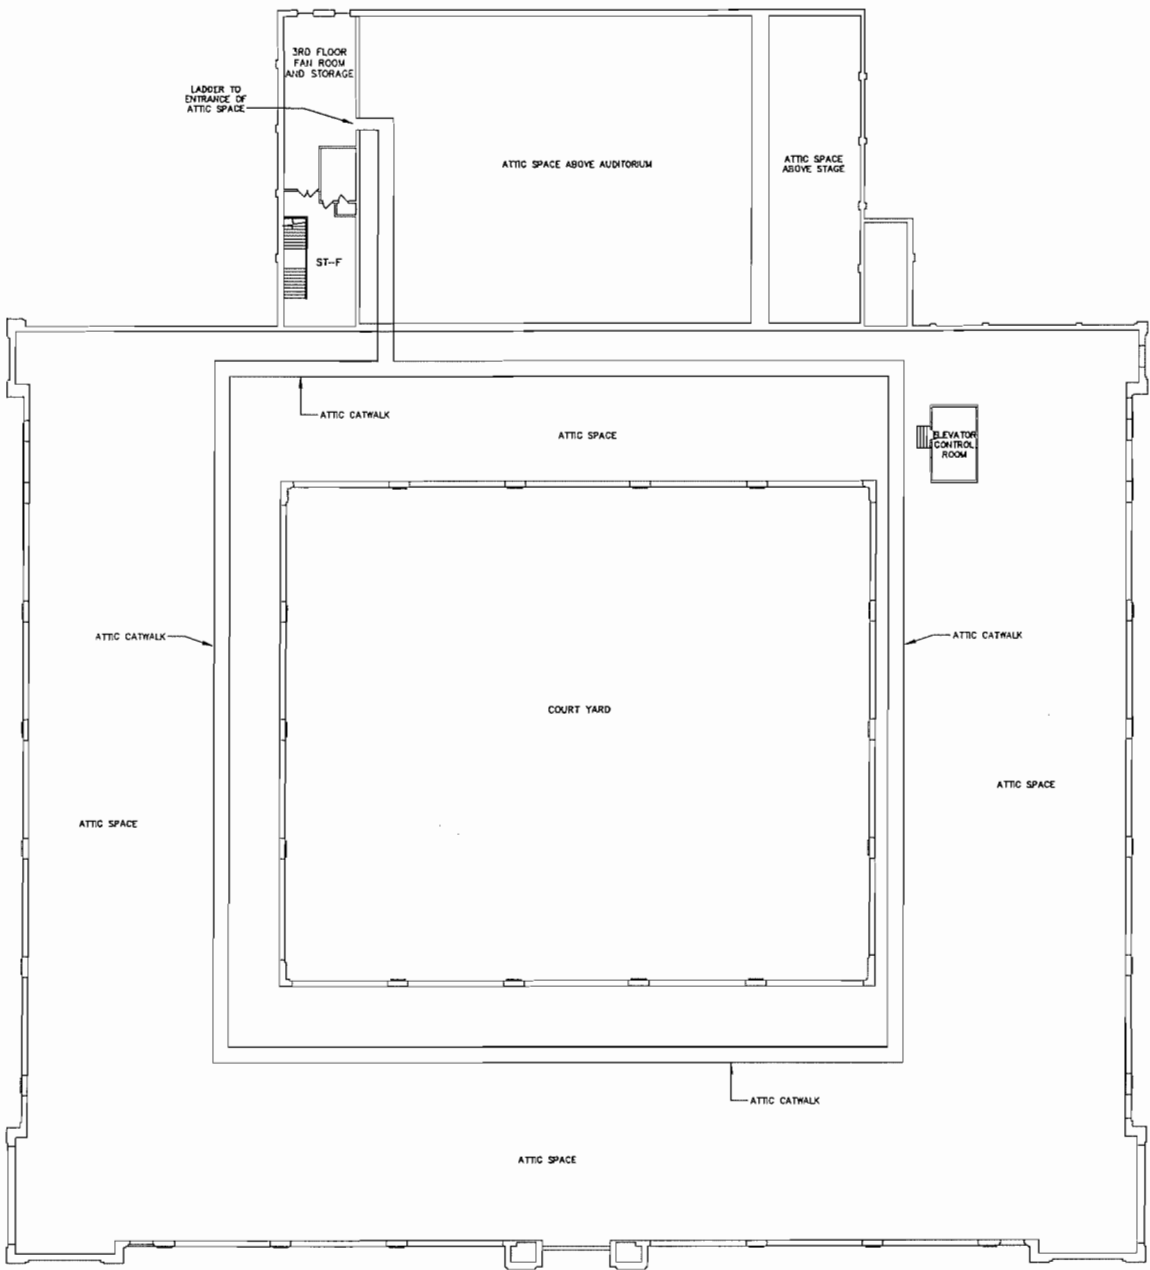

KEY — MISCELLANEOUS ACM
ASBESTOS CONTAINING
MISCELLANEOUS MATERIALS WERE
NOT FOUND ON THIS LEVEL

ATTIC PLAN
NOT TO SCALE

Guzek Associates, Inc.
Mechanical, Electrical, Structural,
Environmental, and Architectural
Engineering
401 Davis Street
Clarks Summit, PA 18411
Phone: (717) 586-9700
Fax: (717) 586-6728
E-Mail: guzekassoc@aol.com

GA

DRAWN BY:	BMT	CHECKED BY:	CN	JOB No.:	SSD 19-751	SCALE:	AS NOTED	DATE:	10/02/2019
DWG. TITLE:									2019 WEST SCRANTON HIGH SCHOOL FLOOR PLANS

ISSUED or REVISED	DATE

Scranton School District
Scranton School District
425 North Washington Avenue
Scranton, PA 18505

Asbestos Management Plans

DRAWING No.:
**A
9**

APPENDIX B

TEST RESULTS FOR SUSPECTED ASBESTOS-CONTAINING MATERIALS:

2016 LABORATORY REPORTS

2016 CHAIN OF CUSTODY

EMSL ANALYTICAL, INC.
LABORATORY PRODUCTS TRAINING

Asbestos Bulk Building Material Chain of Custody

EMSL Order Number (Lab Use Only):

EMSL ANALYTICAL, INC.
200 ROUTE 130 NORTH
CINNAMINSON, NJ 08077
PHONE: (800) 220-3675
FAX: (856) 786-5974

Company: Guzek Associates, Inc.		EMSL-Bill to: <input type="checkbox"/> Same <input type="checkbox"/> Different If Bill to is Different note instructions in Comments**	
Street: 401 Davis Street		Third Party Billing requires written authorization from third party	
City: Clarks Summit	State/Province: PA	Zip/Postal Code: 18414	Country: U.S.A.
Report To (Name): Chris Notari		Telephone #: 570-586-9700	
Email Address: guzekassoc@aol.com		Fax #: 570-586-6728	Purchase Order:
Project Name/Number: SSD 16_751 West Scranton High		Please Provide Results: <input type="checkbox"/> Fax <input checked="" type="checkbox"/> Email	
U.S. State Samples Taken: Pennsylvania		CT Samples: <input type="checkbox"/> Commercial/Taxable <input type="checkbox"/> Residential/Tax Exempt	
Turnaround Time (TAT) Options* - Please Check			
<input type="checkbox"/> 3 Hour <input type="checkbox"/> 6 Hour <input type="checkbox"/> 24 Hour <input type="checkbox"/> 48 Hour <input type="checkbox"/> 72 Hour <input checked="" type="checkbox"/> 96 Hour <input type="checkbox"/> 1 Week <input type="checkbox"/> 2 Week			
*For TEM Air 3 hr through 6 hr, please call ahead to schedule. *There is a premium charge for 3 Hour TEM AHERA or EPA Level II TAT. You will be asked to sign an authorization form for this service. Analysis completed in accordance with EMSL's Terms and Conditions located in the Analytical Price Guide.			
PLM - Bulk (reporting limit)		TEM - Bulk	
<input checked="" type="checkbox"/> PLM EPA 600/R-93/116 (<1%)		<input type="checkbox"/> TEM EPA NOB - EPA 600/R-93/116 Section 2.5.5.1	
<input type="checkbox"/> PLM EPA NOB (<1%)		<input type="checkbox"/> NY ELAP Method 198.4 (TEM)	
Point Count <input type="checkbox"/> 400 (<0.25%) <input type="checkbox"/> 1000 (<0.1%)		<input type="checkbox"/> Chatfield Protocol (semi-quantitative)	
Point Count w/Gravimetric <input type="checkbox"/> 400 (<0.25%) <input type="checkbox"/> 1000 (<0.1%)		<input type="checkbox"/> TEM % by Mass - EPA 600/R-93/116 Section 2.5.5.2	
<input type="checkbox"/> NIOSH 9002 (<1%)		<input type="checkbox"/> TEM Qualitative via Filtration Prep Technique	
<input type="checkbox"/> NY ELAP Method 198.1 (friable in NY)		<input type="checkbox"/> TEM Qualitative via Drop Mount Prep Technique	
<input type="checkbox"/> NY ELAP Method 198.6 NOB (non-friable-NY)		Other	
<input type="checkbox"/> OSHA ID-191 Modified		<input type="checkbox"/>	
<input type="checkbox"/> Standard Addition Method			
<input type="checkbox"/> Check For Positive Stop - Clearly Identify Homogenous Group		Date Sampled: 07-27-2016	
Samplers Name: Chris Notari / Brent Tripp		Samplers Signature: <i>Brent Tripp</i>	
Sample #	HA #	Sample Location	Material Description
01		Bioler Room Storage	Column Plaster
02		Crawl Space	Wrap Over Fiberglass
03		Crawl Space	Corrugated Ceiling
04		Crawl Space	Bottom of Beam (Softer Block)
05		Crawl Space	Corrugated Ceiling Block
06		Storage Space	Bottom of Beam
07		Storage Space	Corrugated Ceiling Block
08		Girl's Weight Room	Floor Leveler
09		Woodshop Storage	Joint Compound
10		Woodshop Storage	Sheetrock
Client Sample # (s):		Total # of Samples: 10	
Relinquished (Client): <i>Brent Tripp</i>		Date: 07-28-201	Time: 3:00 PM
Received (Lab): <i>RD EMSL</i>		Date: 7-29-2016	Time: 9:45 AM
Comments/Special Instructions:			

15 JUL 29 AM 11:18
RECEIVED
EMSL
CINNAMINSON, NJ

60

OrderID: 041620926

EMSL ANALYTICAL, INC.
LABORATORY PRODUCTS TRAINING

Asbestos Bulk Building Material Chain of Custody

EMSL Order Number (Lab Use Only):

EMSL ANALYTICAL, INC.
200 ROUTE 130 NORTH
CINNAMINSON, NJ 08077
PHONE: (800) 220-3675
FAX: (856) 786-5974

Additional Pages of the Chain of Custody are only necessary if needed for additional sample information

Sample #	HA #	Sample Location	Material Description
11		Maintenance Office	Joint Compound
12		Hallway Between Woodshop Storage & Woodshop (Storage Room)	Tar Floor
13		Woodshop (paint/storage)	Wall Concrete
14		Boy's Locker Room	Plaster (Single Layer Only)
15		Football Conference Room	2x4 Ceiling Tile
16		Football Conference Room	Joint Compound
17		Football Conference Room	Sheetrock
18		Fan Room #3	Fiberglass Sealing Ends
19		Fan Room #3	Ceiling Block
20 W		Stairwell "D"	Plaster White Layer
21 B		Stairwell "D"	Plaster Base Layer
22 W		Room 105	Plaster White Layer
22 B		Room 105	Plaster Base Layer
23 W		Auditorium	Plaster White Layer
24 B		Auditorium	Plaster Base Layer
25 W		Stage	Plaster White Layer
26 B		Stage	Plaster Base Layer
27		Faculty Lounge	Thick Wall Paper
28		Boy's Room, Urinal Chase (Next to Room 106)	Corrugated Wall Board
29		Room 102	Thick Burlap Wall Paper
30 W		Room 129	Plaster White Layer
31 B		Room 129	Plaster Base Layer
32		Hallyway	Textured Ceiling
33 W		2nd Floor, Room 218	Plaster White Layer
*Comments/Special Instructions: 			

RECEIVED
EMSL
CINNAMINSON, NJ
16 JUL 29 AM 11:18



EMSL ANALYTICAL, INC.
LABORATORY • PRODUCTS • TRAINING

Asbestos Bulk Building Material Chain of Custody

EMSL Order Number (Lab Use Only):

EMSL ANALYTICAL, INC.
200 ROUTE 130 NORTH
CINNAMINSON, NJ 08077
PHONE: (800) 220-3675
FAX: (856) 786-5974

Additional Pages of the Chain of Custody are only necessary if needed for additional sample information

Sample #	HA #	Sample Location	Material Description
34 B		2nd Floor, Room 218	Plaster Base Layer
35		2nd Floor, Library	Linoleum Flooring Under Carpet
36 W		2nd Floor, Room 210	Plaster White Layer
37 B		2nd Floor, Room 210	Plaster Base Layer
38		2nd Floor, Room 206	Linoleum Flooring
39 W		2nd Floor, Room 202	Plaster White Layer
40 B		2nd Floor, Room 206	Plaster Base Layer
41		2nd Floor, Storage Room, Across from Room 215	Single Layer Plaster Ceiling
42		2nd Floor, Storage Room, Across from Room 215	Cement Like Block on Bottom of Beams
43		2nd Floor, Storage Room, Across from Room 211	Single Layer Plaster Ceiling
44 W		3rd Floor, Room 323	Plaster White Layer
45 B		3rd Floor, Room 323	Plaster Base Layer
46 W		3rd Floor, Room 310	Plaster White Layer
47 B		3rd Floor, Room 310	Plaster Base Layer
48 W		3rd Floor, Auditorium Attic	Plaster White Layer
49 B		3rd Floor, Auditorium Attic	Plaster Base Layer
50 W		3rd Floor, Auditorium Attic	Plaster White Layer
51 B		3rd Floor, Auditorium Attic	Plaster Base Layer
52 W		3rd Floor, Storage Area off Cafeteria	Plaster White Layer
53 B		3rd Floor, Storage Area off Cafeteria	Plaster Base Layer
54		Main Attic	Roof Decking
55		Exterior of Building - Roof	Material on Duct
56		Exterior of Building	Window Frame Caulking
57		Exterior of Building - Front of School	Door Frame Caulking
*Comments/Special Instructions:			

RECEIVED
 EMSL
 CINNAMINSON, NJ
 15 JUL 29 AM 11:18



EMSL ANALYTICAL, INC.
LABORATORY • PRODUCTS • TRAINING

EMSL Order Number (*Lab Use Only*):

Additional Pages of the Chain of Custody are only necessary if needed for additional sample information

[illegible]

**EMSL Analytical, Inc.**

200 Route 130 North Cinnaminson, NJ 08077

Tel/Fax: (800) 220-3675 / (856) 786-5974

http://www.EMSL.com / cinnasblab@EMSL.com

EMSL Order: 041620926

Customer ID: CLAG50

Customer PO:

Project ID:

Attention: Chris Notari

Guzek Associates, Inc.

401 Davis Street

Clarks Summit, PA 18411

Phone: (570) 586-9700**Fax:** (570) 586-6728**Received Date:** 07/29/2016 9:45 AM**Analysis Date:** 08/02/2016 - 08/03/2016**Collected Date:** 07/27/2016**Project:** SSD 16_751 West Scranton High

Test Report: Asbestos Analysis of Bulk Materials via EPA 600/R-93/116 Method using Polarized Light Microscopy

Sample	Description	Appearance	Non-Asbestos		Asbestos
			% Fibrous	% Non-Fibrous	% Type
01 041620926-0001	Boiler Room Storage - Column Plaster	Gray Non-Fibrous Homogeneous		100% Non-fibrous (Other)	None Detected
02 041620926-0002	Crawl Space - Wrap over Fiberglass	White Fibrous Homogeneous	65% Cellulose	35% Non-fibrous (Other)	None Detected
03 041620926-0003	Crawl Space - Corrugated Ceiling	White Non-Fibrous Homogeneous	20% Cellulose	80% Non-fibrous (Other)	None Detected
04 041620926-0004	Crawl Space - Bottom of Beam (Softer Block)	Tan Non-Fibrous Homogeneous		100% Non-fibrous (Other)	None Detected
05 041620926-0005	Crawl Space - Corrugated Ceiling Block	Gray Fibrous Homogeneous	20% Cellulose	80% Non-fibrous (Other)	None Detected
06 041620926-0006	Storage Space - Bottom of Beam	White Non-Fibrous Homogeneous		100% Non-fibrous (Other)	None Detected
07 041620926-0007	Storage Space - Corrugated Ceiling Block Floor	Gray Fibrous Homogeneous	10% Cellulose	75% Non-fibrous (Other)	15% Chrysotile
08-Leveler 041620926-0008	Girl's Weight Room - Floor Leveler	White Non-Fibrous Homogeneous		100% Non-fibrous (Other)	None Detected
08-Mastic 041620926-0008A	Girl's Weight Room - Mastic	Yellow Non-Fibrous Homogeneous		100% Non-fibrous (Other)	None Detected
09 041620926-0009	Woodshop Storage - Joint Compound	White Non-Fibrous Homogeneous		100% Non-fibrous (Other)	None Detected
10 041620926-0010	Woodshop Storage - Sheetrock	White Fibrous Homogeneous	15% Cellulose 10% Glass	75% Non-fibrous (Other)	None Detected
11 041620926-0011	Maintenance Office - Joint Compound	White Non-Fibrous Homogeneous	15% Cellulose	85% Non-fibrous (Other)	None Detected
12 041620926-0012	Hallway Between Woodshop Storage and Woodshop (Storage Room) - Tar Floor	Brown Non-Fibrous Homogeneous	10% Synthetic	90% Non-fibrous (Other)	None Detected
13 041620926-0013	Woodshop (Paint/Storage) - Wall Concrete	Gray Non-Fibrous Homogeneous		100% Non-fibrous (Other)	None Detected
14 041620926-0014	Boy's Locker Room - Plaster (Single Layer Only)	Gray Non-Fibrous Homogeneous		100% Non-fibrous (Other)	None Detected

Initial report from: 08/03/2016 07:49:58

**EMSL Analytical, Inc.**

200 Route 130 North Cinnaminson, NJ 08077

Tel/Fax: (800) 220-3675 / (856) 786-5974

http://www.EMSL.com / cinnaslab@EMSL.com

EMSL Order: 041620926

Customer ID: CLAG50

Customer PO:

Project ID:

**Test Report: Asbestos Analysis of Bulk Materials via EPA 600/R-93/116 Method using Polarized
Light Microscopy**

Sample	Description	Appearance	Non-Asbestos		Asbestos % Type
			% Fibrous	% Non-Fibrous	
15	Football Conference Room - 2x4 Ceiling Tile	White Fibrous Homogeneous	60% Cellulose 30% Min. Wool	10% Non-fibrous (Other)	None Detected
041620926-0015					
16	Football Conference Room - Joint Compound	White Non-Fibrous Homogeneous		100% Non-fibrous (Other)	None Detected
041620926-0016					
17	Football Conference Room - Sheetrock	White Fibrous Homogeneous	15% Cellulose 10% Glass	75% Non-fibrous (Other)	None Detected
041620926-0017					
18	Fan Room #3 - Fiberglass Sealing Ends	White Fibrous Homogeneous	25% Glass	75% Non-fibrous (Other)	None Detected
041620926-0018					
19	Fan Room #3 - Ceiling Block	White Non-Fibrous Homogeneous		100% Non-fibrous (Other)	None Detected
041620926-0019					
20W	Stairwell "D" - Plaster White Layer	White Non-Fibrous Homogeneous		100% Non-fibrous (Other)	None Detected
041620926-0020					
21B	Stairwell "D" - Plaster Base Layer	Gray Non-Fibrous Homogeneous	5% Cellulose	95% Non-fibrous (Other)	None Detected
041620926-0021					
22W	Room 105 - Plaster White Layer	Gray Non-Fibrous Homogeneous		100% Non-fibrous (Other)	None Detected
041620926-0022					
22B	Room 105 - Plaster Base Layer	Gray Non-Fibrous Homogeneous	10% Hair	90% Non-fibrous (Other)	None Detected
041620926-0023					
23W	Auditorium - Plaster White Layer	White Non-Fibrous Homogeneous		100% Non-fibrous (Other)	None Detected
041620926-0024					
24B	Auditorium - Plaster Base Layer	Gray Non-Fibrous Homogeneous	10% Synthetic	90% Non-fibrous (Other)	None Detected
041620926-0025					
25W	Stage - Plaster White Layer	Gray Non-Fibrous Homogeneous	5% Hair	95% Non-fibrous (Other)	None Detected
041620926-0026					
26B	Stage - Plaster Base Layer	Gray Non-Fibrous Homogeneous	15% Cellulose	85% Non-fibrous (Other)	None Detected
041620926-0027					
27	Faculty Lounge - Thick Wall Paper	Brown Non-Fibrous Homogeneous		100% Non-fibrous (Other)	None Detected
041620926-0028					
28	Boy's Room Urinal Chase Nest to Room 106 - Corrugated Wall Board	Gray Fibrous Homogeneous	20% Cellulose	55% Non-fibrous (Other)	25% Chrysotile
041620926-0029					
29-Wallpaper	Room 102 - Thick Burlap Wall Paper	Brown Fibrous Homogeneous	90% Cellulose	10% Non-fibrous (Other)	None Detected
041620926-0030					
29-Mastic	Room 102 - Mastic	Brown Non-Fibrous Homogeneous		100% Non-fibrous (Other)	None Detected
041620926-0030A					
30W	Room 129 - Plaster White Layer	White Non-Fibrous Homogeneous		100% Non-fibrous (Other)	None Detected
041620926-0031					
31B	Room 129 - Plaster Base Layer	Gray Non-Fibrous Homogeneous		100% Non-fibrous (Other)	None Detected
041620926-0032					

Initial report from: 08/03/2016 07:49:58

**EMSL Analytical, Inc.**

200 Route 130 North Cinnaminson, NJ 08077

Tel/Fax: (800) 220-3675 / (856) 786-5974

http://www.EMSL.com / cinnaslab@EMSL.com

EMSL Order: 041620926**Customer ID:** CLAG50**Customer PO:****Project ID:**

**Test Report: Asbestos Analysis of Bulk Materials via EPA 600/R-93/116 Method using Polarized
Light Microscopy**

Sample	Description	Appearance	Non-Asbestos		Asbestos % Type
			% Fibrous	% Non-Fibrous	
32 041620926-0033	Hallway - Texture Ceiling	White Non-Fibrous Homogeneous		100% Non-fibrous (Other)	None Detected
33W 041620926-0034	2nd Floor Room 216 - Plaster White Layer	White Non-Fibrous Homogeneous		100% Non-fibrous (Other)	None Detected
34B 041620926-0035	2nd Floor Room 216 - Plaster Base Layer	Gray Fibrous Homogeneous	10% Hair	90% Non-fibrous (Other)	None Detected
35-Linoleum Flooring 041620926-0036	2ND Floor Library - Linoleum Flooring Under Carpet	Brown Fibrous Homogeneous	20% Cellulose	80% Non-fibrous (Other)	None Detected
35-Mastic 041620926-0036A	2ND Floor Library - Mastic	Tan Non-Fibrous Homogeneous		100% Non-fibrous (Other)	None Detected
36W 041620926-0037	2nd Floor Room 210 - Plaster White Layer	White Non-Fibrous Homogeneous		100% Non-fibrous (Other)	None Detected
37B 041620926-0038	2nd Floor Room 210 - Plaster Base Layer	Gray Fibrous Homogeneous	10% Synthetic	90% Non-fibrous (Other)	None Detected
38 041620926-0039	2nd Floor Room 206 - Linoleum Flooring	Brown Non-Fibrous Homogeneous	15% Cellulose	85% Non-fibrous (Other)	None Detected
39W 041620926-0040	2nd Floor Room 202 - Plaster White Layer	White Non-Fibrous Homogeneous		100% Non-fibrous (Other)	None Detected
40B 041620926-0041	2nd Floor Room 206 - Plaster Base Layer	Gray Non-Fibrous Homogeneous	5% Synthetic	95% Non-fibrous (Other)	None Detected
41 041620926-0042	2nd Floor Storage Room Across from Room 215 - Single Layer Plaster Ceiling	Gray Non-Fibrous Homogeneous		100% Non-fibrous (Other)	None Detected
42 041620926-0043	2nd Floor Storage Room Across from Room 215 - Cement Like Block on Bottom of Beams	Gray Non-Fibrous Homogeneous	10% Cellulose	90% Non-fibrous (Other)	None Detected
43 041620926-0044	2nd Floor Storage Room Across Frpm Room 211 - Single Layer Plaster Ceiling	Gray Fibrous Homogeneous	10% Synthetic	90% Non-fibrous (Other)	None Detected
44W 041620926-0045	3rd Floor Room 323 - Plaster White Layer	White Non-Fibrous Homogeneous		100% Non-fibrous (Other)	None Detected
45B 041620926-0046	3rd Floor Room 323 - Plaster Base Layer	Gray Fibrous Homogeneous	10% Synthetic	90% Non-fibrous (Other)	None Detected
46W 041620926-0047	3rd Floor Room 310 - Plaster White Layer	White Non-Fibrous Homogeneous		100% Non-fibrous (Other)	None Detected
47B 041620926-0048	3rd Floor Room 310 - Plaster Base Layer	Gray Non-Fibrous Homogeneous	10% Synthetic	90% Non-fibrous (Other)	None Detected
48W 041620926-0049	3rd Floor Auditorium Attic - Plaster White Layer	White Non-Fibrous Homogeneous		96% Non-fibrous (Other)	4% Chrysotile

Initial report from: 08/03/2016 07:49:58

**EMSL Analytical, Inc.**

200 Route 130 North Cinnaminson, NJ 08077

Tel/Fax: (800) 220-3675 / (856) 786-5974

http://www.EMSL.com / cinnaslab@EMSL.com

EMSL Order: 041620926

Customer ID: CLAG50

Customer PO:

Project ID:

Test Report: Asbestos Analysis of Bulk Materials via EPA 600/R-93/116 Method using Polarized Light Microscopy

Sample	Description	Appearance	Non-Asbestos		Asbestos % Type
			% Fibrous	% Non-Fibrous	
49B 041620926-0050	3rd Floor Auditorium Attic - Plaster Base Layer	Gray Non-Fibrous Homogeneous	15% Cellulose	85% Non-fibrous (Other)	<1% Chrysotile
50W 041620926-0051	3rd Floor Auditorium Attic - Plaster White Layer	White Non-Fibrous Homogeneous		96% Non-fibrous (Other)	4% Chrysotile
51B 041620926-0052	3rd Floor Auditorium Attic - Plaster Base Layer	Gray Fibrous Homogeneous	10% Cellulose	90% Non-fibrous (Other)	<1% Chrysotile
52W 041620926-0053	2nd Floor Storage Area off Cafeteria - Plaster White Layer	White Non-Fibrous Homogeneous		100% Non-fibrous (Other)	None Detected
53B 041620926-0054	2nd Floor Storage Area off Cafeteria - Plaster Base Layer	Gray Fibrous Homogeneous	10% Cellulose	90% Non-fibrous (Other)	<1% Chrysotile
54 041620926-0055	Main Attic - Roof Decking	Gray Fibrous Homogeneous	10% Cellulose	90% Non-fibrous (Other)	<1% Chrysotile
55 041620926-0056	Exterior of Building Roof - Material on Duct	Black Non-Fibrous Homogeneous		97% Non-fibrous (Other)	3% Chrysotile
56 041620926-0057	Exterior Of Building - Window Frame Caulking	Gray Fibrous Homogeneous		95% Non-fibrous (Other)	5% Chrysotile
57 041620926-0058	Exterior Of Building Front of School - Door Frame Caulking	Gray Non-Fibrous Homogeneous	15% Fibrous (Other)	85% Non-fibrous (Other)	None Detected
58 041620926-0059	Exterior Of Building - Cementitious Expansion Joint	Gray Non-Fibrous Homogeneous		100% Non-fibrous (Other)	None Detected
59 041620926-0060	Exterior Of Building in Rear Door Next to Pit - Door Caulking	Brown Non-Fibrous Homogeneous		95% Non-fibrous (Other)	5% Chrysotile

Analyst(s)

Andrew Coward (63)

Benjamin Ellis, Laboratory Manager
or Other Approved Signatory

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Samples analyzed by EMSL Analytical, Inc. Cinnaminson, NJ NVLAP Lab Code 101048-0, AIHA-LAP, LLC-IHLAP Lab 100194, NYS ELAP 10872, NJ DEP 03036, PA ID# 68-00367

Initial report from: 08/03/2016 07:49:58

OrderID: 041621892

EMSL ANALYTICAL, INC.
LABORATORY PRODUCTS - 11/11/2010


Asbestos Bulk Building Material Chain of Custody

EMSL Order Number (Lab Use Only):

041621892

EMSL ANALYTICAL, INC.
200 ROUTE 130 NORTH
CINNAMINSON, NJ 08077
PHONE: (800) 220-3675
FAX: (856) 786-5974

Company: Guzek Associates, Inc.		EMSL-Bill to: <input type="checkbox"/> Same <input type="checkbox"/> Different If Bill to is Different note Instructions in Comments**	
Street: 401 Davis Street		Third Party Billing requires written authorization from third party	
City: Clarks Summit	State/Province: PA	Zip/Postal Code: 18414	Country: U.S.A.
Report To (Name): Chris Notari		Telephone #: 570-586-9700	
Email Address: guzekassoc@aol.com		Fax #: 570-586-6728	Purchase Order:
Project Name/Number: SSD 16_751 West Scranton High		Please Provide Results: <input type="checkbox"/> Fax <input checked="" type="checkbox"/> Email	
U.S. State Samples Taken: Pennsylvania		CT Samples: <input type="checkbox"/> Commercial/Taxable <input type="checkbox"/> Residential/Tax Exempt	
Turnaround Time (TAT) Options* - Please Check			
<input type="checkbox"/> 3 Hour <input type="checkbox"/> 6 Hour <input type="checkbox"/> 24 Hour <input type="checkbox"/> 48 Hour <input type="checkbox"/> 72 Hour <input checked="" type="checkbox"/> 96 Hour <input type="checkbox"/> 1 Week <input type="checkbox"/> 2 Week			
*For TEM Air 3 hr through 6 hr, please call ahead to schedule. There is a premium charge for 3 Hour TEM AHERA or EPA Level II TAT. You will be asked to sign an authorization form for this service. Analysis completed in accordance with EMSL's Terms and Conditions located in the Analytical Price Guide			
PLM - Bulk (reporting limit)		TEM - Bulk	
<input checked="" type="checkbox"/> PLM EPA 600/R-93/116 (<1%) <input type="checkbox"/> PLM EPA NOB (<1%) Point Count <input type="checkbox"/> 400 (<0.25%) <input type="checkbox"/> 1000 (<0.1%) Point Count w/Gravimetric <input type="checkbox"/> 400 (<0.25%) <input type="checkbox"/> 1000 (<0.1%) <input type="checkbox"/> NIOSH 9002 (<1%) <input type="checkbox"/> NY ELAP Method 198.1 (friable in NY) <input type="checkbox"/> NY ELAP Method 198.6 NOB (non-friable-NY) <input type="checkbox"/> OSHA ID-191 Modified <input type="checkbox"/> Standard Addition Method		<input type="checkbox"/> TEM EPA NOB - EPA 600/R-93/116 Section 2.5.5.1 <input type="checkbox"/> NY ELAP Method 198.4 (TEM) <input type="checkbox"/> Chatfield Protocol (semi-quantitative) <input type="checkbox"/> TEM % by Mass - EPA 600/R-93/116 Section 2.5.5.2 <input type="checkbox"/> TEM Qualitative via Filtration Prep Technique <input type="checkbox"/> TEM Qualitative via Drop Mount Prep Technique Other <input type="checkbox"/>	
<input type="checkbox"/> Check For Positive Stop - Clearly Identify Homogenous Group		Date Sampled: 08-05-2016	
Samplers Name: Chris Notari / Brent Tripp		Samplers Signature: <i>Brent m Tripp</i>	
Sample #	HA #	Sample Location	Material Description
101		Basement - Storage Room	Ceiling Block
102		Basement - Storage Room	Ceiling Block
103		Basement - Storage Room	Ceiling Block
104 W		Basement - Storage Room	Ceiling Block White Layer
104 B		Basement - Storage Room	Ceiling Block Base Layer
105		Basement - Pump Room	Ceiling Block Paint Surface Layer
106		Basement - Pump Room	Ceiling Block
107		Basement - Boiler Room	Ceiling Block
108		Basement - Crawl Space	Ceiling Block
109		Basement - Crawl Space	Ceiling Block
Client Sample # (s):		Total # of Samples: Sixteen (16)	
Relinquished (Client): <i>Brent m Tripp</i>		Date: 08-05-2016	Time: 3:00 PM
Received (Lab): <i>RD EMSL FL</i>		Date: 8-8-2016	Time: 9:10 AM
Comments/Special Instructions:			

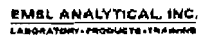

EMSL Order Number (*Lab Use Only*): _____

0416 2,852

Additional Pages of the Chain of Custody are only necessary if needed for additional sample information

Page 2 of 2 pages

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EMSL Order: 041621892**Customer ID:** CLAG50**Customer PO:****Project ID:**

Attention: Chris Notari
 Guzek Associates, Inc.
 401 Davis Street
 Clarks Summit, PA 18411

Phone: (570) 586-9700**Fax:** (570) 586-6728**Received Date:** 08/08/2016 9:10 AM**Analysis Date:** 08/09/2016 - 08/10/2016**Collected Date:** 08/05/2016**Project:** SSD 16_751 West Scranton High

**Test Report: Asbestos Analysis of Bulk Materials via EPA 600/R-93/116 Method using Polarized
 Light Microscopy**

Sample	Description	Appearance	Non-Asbestos		Asbestos
			% Fibrous	% Non-Fibrous	% Type
101 041621892-0001	Basement Storage Room - Ceiling Block	White Fibrous Homogeneous		70% Non-fibrous (Other)	30% Chrysotile
102 041621892-0002	Basement Storage Room - Ceiling Block	White Non-Fibrous Homogeneous		100% Non-fibrous (Other)	None Detected
103 041621892-0003	Basement Storage Room - Ceiling Block	White Non-Fibrous Homogeneous	10% Cellulose	90% Non-fibrous (Other)	None Detected
104-W 041621892-0004	Basement Storage Room - Ceiling Block White Layer	White Non-Fibrous Homogeneous		100% Non-fibrous (Other)	None Detected
104-B 041621892-0005	Basement Storage Room - Ceiling Block Base Layer	Brown/Gray Non-Fibrous Homogeneous	10% Cellulose	90% Non-fibrous (Other)	None Detected
105 041621892-0006	Basement Pump Room - Ceiling Block Paint Surface Layer	White Non-Fibrous Homogeneous		100% Non-fibrous (Other)	None Detected
106 041621892-0007	Basement Pump Room - Ceiling Block	Gray/White Non-Fibrous Homogeneous	5% Cellulose	95% Non-fibrous (Other)	None Detected
107 041621892-0008	Basement Boiler Room - Ceiling Block	Gray/White Non-Fibrous Homogeneous	10% Cellulose	90% Non-fibrous (Other)	None Detected
108 041621892-0009	Basement Crawl Space - Ceiling Block	Gray Non-Fibrous Homogeneous	10% Cellulose	90% Non-fibrous (Other)	None Detected
109 041621892-0010	Basement Crawl Space - Ceiling Block	Gray Non-Fibrous Homogeneous	5% Cellulose	95% Non-fibrous (Other)	None Detected
110 041621892-0011	Basement Fan Room - Ceiling Block	Gray Non-Fibrous Homogeneous	10% Cellulose	90% Non-fibrous (Other)	None Detected
111 041621892-0012	Basement Wrestling Room - Packing around 12" Sewer Pipe	Gray/White Non-Fibrous Homogeneous		100% Non-fibrous (Other)	None Detected
112 041621892-0013	3rd Floor Projector Room - Plaster Ceiling (one layer only)	Gray Non-Fibrous Homogeneous		100% Non-fibrous (Other)	None Detected
113-W 041621892-0014	3rd Floor Projector Room - Plaster White Layer	Gray/White Non-Fibrous Homogeneous		100% Non-fibrous (Other)	None Detected
114-B 041621892-0015	3rd Floor Outside Projector Room - Plaster Base Layer	Gray Non-Fibrous Homogeneous		100% Non-fibrous (Other)	None Detected

Initial report from: 08/11/2016 14:29:45

**EMSL Analytical, Inc.**

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EMSL Order: 041621892

Customer ID: CLAG50

Customer PO:

Project ID:

**Test Report: Asbestos Analysis of Bulk Materials via EPA 600/R-93/116 Method using Polarized
Light Microscopy**

Sample	Description	Appearance	<u>Non-Asbestos</u>		<u>Asbestos</u>
			% Fibrous	% Non-Fibrous	% Type
115	3rd Floor Auditorium	Gray	10% Cellulose	90% Non-fibrous (Other)	None Detected
	Attic Space - Ceiling	Non-Fibrous			
041621892-0016	Block	Homogeneous			

Analyst(s)

Edward Zambrano (2)

Seri Smith (4)

William Nguyen (10)

Benjamin Ellis, Laboratory Manager
or Other Approved Signatory

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Initial report from: 08/11/2016 14:29:45